# CITY OF AUSTIN Board of Adjustment/Sign Review Board Decision Sheet

DATE:	January 12, 2015	CASE NUMBER: C16-2015-0002
Y	Jeff Jack - Chair	
Y	Michael Von Ohlen (2 <sup>nd</sup> the Motion)	
Y_	Melissa Whaley Hawthorne - Vice Ch	air
Y	Sallie Burchett	
Y_	Ricardo De Camps (Motion to PP to	Feb 9, 2015)
Y	Brian King	
Y	Vincent Harding	
Y	Cathy French	•

**APPLICANT: Michael Hunter** 

OWNER: North Austin Medical Center ADDRESS: 12221 MOPAC EXPY NB

VARIANCE REQUESTED: A.1. for sign 11, Section 25-10-124 (B) (1) (b) (Scenic Roadway Sign District Regulations) to increase the maximum area of a freestanding sign from 64 feet (required) to 90 feet (requested); and to A.2. for sign 11. Section 25-10-124 (F) (Scenic Roadway Sign District Regulations) to permit internal lighting of sign; and to A.3. for sign 11, Section 25-10-124 (G) (Scenic Roadway Sign District Regulations) to permit signs to be less than 12 feet from street right-of-way (required) to 11 feet from street right-of-way (requested); and to A.4. for sign 11, Section 25-10-191 (F) (Setback and Structural Requirements) a sign within 12 feet of street right-of-way must have either: 1) a height of not more than 30 inches; or 2) a clearance of nine feet (required) to 11 feet from street right-of-way, height of 77 inches and clearance of 7 inches (requested); and to A.5. for sign 11, Section 25-10-23 (B)(7)(Hazardous Signs Described and Prohibited) a person may not install, maintain or use a sign that has less than 9 feet of clearance and is located within a triangle formed by connecting the intersection point of two streets and the points 45 feet from the intersection point on the street frontage property line of each intersecting street (required) to 7 inches clearance and located within a triangle formed by connecting the intersection points 26 ft from the street frontage property line (requested); and to B.1. for sign 21, Section 25-10-124 (F) (Scenic Roadway Sign District Regulations) to permit internal lighting of sign; and to B.2. for sign 21, Section 25-10-124 (G) (Scenic Roadway Sign District Regulations) to permit signs to be less than 12 feet from street right-of-way (required) to 9 feet 9 inches from street right-of-way (requested); and to B.3. for sign 21, Section 25-10-191 (F) (Setback and Structural Requirements) a sign within 12 feet of street right-of-way must have either: 1) a height of not more than 30 inches; or 2) a clearance of nine feet (required) to 9 feet 9 inches from street right-of-way, height of 81 inches and clearance of 1 foot (requested); and to B.4. for sign 21, Section 25-10-23

(B)(7)(Hazardous Signs Described and Prohibited) a person may not install, maintain or use a sign that has less than 9 feet of clearance and is located within a triangle formed by connecting the intersection point of two streets and the points 45 feet from the intersection point on the street frontage property line of each intersecting street (required) to 7 inches clearance and located within a triangle formed by connecting the intersection points 19 ft 9 inches from the street frontage property line (requested); and to C.1. for sign 24, Section 25-10-124 (F) (Scenic Roadway Sign District Regulations) to permit internal lighting of sign: and to C.2, for sign 24, Section 25-10-124 (G) (Scenic Roadway Sign District Regulations) to permit signs to be less than 12 feet from street right-of-way (required) to 9 feet from street right-of-way (requested); and to C.3. for sign 24, Section 25-10-191 (F) (Setback and Structural Requirements) a sign within 12 feet of street right-of-way must have either: 1) a height of not more than 30 inches; or 2) a clearance of nine feet (required) to 9 feet from street right-of-way, height of 120 inches and clearance of 3 inches(requested); and to C.4. for sign 24. Section 25-10-23 (B)(7)(Hazardous Signs Described and Prohibited) a person may not install, maintain or use a sign that has less than 9 feet of clearance and is located within a triangle formed by connecting the intersection point of two streets and the points 45 feet from the intersection point on the street frontage property line of each intersecting street (required) to 3 inches clearance and located within a triangle formed by connecting the intersection points 19 ft from the street frontage property line (requested) and to D.1. for sign 26, Section 25-10-124 (F) (Scenic Roadway Sign District Regulations) to permit internal lighting of sign; and to D.2. for sign 26, Section 25-10-124 (G) (Scenic Roadway Sign District Regulations) to permit signs to be less than 12 feet from street right-of-way (required) to 0 feet from street right-of-way (requested); and to D.3. for sign 26, Section 25-10-191 (F) (Setback and Structural Requirements) a sign within 12 feet of street right-of-way must have either: 1) a height of not more than 30 inches; or 2) a clearance of nine feet (required) to 0 feet from street right-of-way, height of 126 inches and clearance of 14 inches (requested); and to D.4. for sign 26, Section 25-10-23 (B)(7)(Hazardous Signs Described and Prohibited) a person may not install, maintain or use a sign that has less than 9 feet of clearance and is located within a triangle formed by connecting the intersection point of two streets and the points 45 feet from the intersection point on the street frontage property line of each intersecting street (required) ) to 14 inches clearance and located within a triangle formed by connecting the intersection points 26 ft from the street frontage property line (requested); and to E. for signs 11, 21, 24, and 26, Section 25-10-124 (B) (Scenic Roadway Sign District Regulations) 1 freestanding sign is permitted on a lot (required) to replace 4 existing signs, retain 5 other freestanding signs - a total of 9 freestanding signs on the lot (requested) in order to replace signs at same location as existing signs within this property in a Scenic Roadway District within a "PUD", Planned Unit Development zoning district.

BOARD'S DECISION: The public hearing was closed on Board Member Ricardo De Camps motion to Postpone to February 9, 2015, Board Member Michael Von Ohlen second on a 8-0 vote; POSTPONED TO February 9, 2015.

## **FINDING:**

1. The variance is necessary because strict enforcement of the Article prohibits and reasonable opportunity to provide adequate signs on the site, considering the unique features of a site such as its dimensions, landscape, or topography, because:

OR,

2. The granting of this variance will not have a substantially adverse impact upon neighboring properties, because:

OR,

3. The granting of this variance will not substantially conflict with the stated purposes of this sign ordinance, because:

AND,

4. Granting a variance would not provide the applicant with a special privilege not enjoyed by others similarly situated or potentially similarly situated, because:

Leane Heldenfels

**Executive Liaison** 

Jeff Jack Chairman

## CITY OF AUSTIN **Board of Adjustment/Sign Review Board Decision Sheet**

APPLICANT: Michael A., Hunter

OWNER: Sheri Dube

ADDRESS: 12221 MOPAC EXPY NB

VARIANCE REQUESTED: The applicant has requested a variance from the maximum number of freestanding signs requirement of Section 25-10-124 (B) in order to replace a damaged freestanding sign providing for a total of 9. freestanding signs (existing) for a Hospital Services (General) use in a "PUD", Planned Unit Development zoning district. (Scenic Roadway Sign district) **GRANTED** 

The applicant has requested a variance to increase the maximum sign face area of a freestanding sign from 64 square feet to 70 square feet in order to replace a damaged freestanding sign providing for a total of 9 freestanding signs (existing) for a Hospital Services (General) use in a "PUD", Planned Unit Development zoning district. (Scenic Roadway Sign district) DENIED

BOARD'S DECISION: The public hearing was closed on Board Member Michael Von Ohlen motion to Grant for only 64 square feet, Board Member Melissa Hawthorne second on a 7-0 vote; GRANTED FOR ONLY 64 SQUARE FEET.

## FINDING:

1. The variance is necessary because strict enforcement of the Article prohibits and reasonable opportunity to provide adequate signs on the site, considering the unique features of a site such as its dimensions, landscape, or topography, because: signs that comply with the article would be too small to be read by vehicular traffic, the north austin medical center is located adjacent to the Mopac Expressway and a very short distance from the off ramp from the expressway to the access road, the location of the hospital is a unique feature of the site

OR.

2. The granting of this variance will not have a substantially adverse impact upon neighboring properties, because: the proposed signage is comparable in size and message to the existing signage

## OR,

3. The granting of this variance will not substantially conflict with the stated purposes of this sign ordinance, because: the proposed signage will provide only essential information, of a size and format that is designed to be legible to patients, emergency service providers and visitors to the hospital

## AND,

4. Granting a variance would not provide the applicant with a special privilege not enjoyed by others similarly situated or potentially similarly situated, because: there are not other hospitals in the immediate area

Susan Walker

**Executive Liaison** 

Jěff Jàck Chairman

CASE#
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# CITY OF AUSTIN APPLICATION TO SIGN REVIEW BOARD SIGN VARIANCE

WARNING: Filing of this appeal stops all affected construction activity.

PLEASE: TYPE AND COMPLETE ALL REQUESTED INFORMATION.


STREET ADDRESS: 12221 N Mo-Pac Expressway Austin, TX 78758
LEGAL DESCRIPTION: Subdivision – 36.3670 A
Lot(s) 1 Block B Outlot Centrum Division The Resub of Blk B & E
I/We_Michael A. Hunter on behalf of myself/ourselves as authorized agent for
St. David's North Austin Medical Center affirm that on October, 2014, hereby apply for a hearing before
the Sign Review Board for consideration:
ERECT - ATTACH - COMPLETE - REMODEL - MAINTAIN
Erect a new monument directional sign
in a zoning district and located within the Scenic Roadway Sign District.

If your variance request is for a reduction in setbacks or height limits, please contact Eben Kellogg with the Electric Utility at (512)322-6050 and send him a scan of your request to <a href="mailto:eben.kellogg@austinenergy.com">eben.kellogg@austinenergy.com</a> before filing your application with this office to discuss your request. The Electric Utility will recommend the board deny your request if it will result in an encroachment into an electric easement or a NESC violation.

NOTE: The Board must determine the existence of, sufficiency of and weight of evidence supporting the findings described below. In order to grant your requeste for a variance, the Board must first make one or more of the findings described under 1, 2, and 3 below; the Board must then make the finding described in item 4 below. If the Board cannot make the required findings, it cannot approve a sign variance.

Therefore, you must complete each of the applicable Findings Statements as part of your application. Failure to do so may result in your application being rejected as incomplete. Please attach any additional support documents.

VARIANCE FINDINGS: I contend that my entitlement to the requested variance is based on the following findings:
1. The variance is necessary because strict enforcement of the Article prohibits any reasonable opportunity to provide adequate signs on the site, considering the unique features of a site such as its dimensions, landscaping, or topography, because: The new proposed sign is of the
same type and design as previously approved signs for this property in Phase 1
approximately 2 years ago.
OR,
2. The granting of this variance will not have a substantially adverse impact upon neighboring properties, because: We are replacing an existing sign of the same nature in the
same location.
OR,
3. The granting of this variance will not substantially conflict with the stated purposes of this sign ordinance, because: The additional size is needed to convey directions to various
medical facilities within the campus
AND,
4. Granting a variance would not provide the applicant with a special privilege not enjoyed by others similarly situated or potentially similarly situated, because: This is an emergency med-
ical facility that needs to be able to convey directional information to those in need of emergency medical care.  APPLICANT CERTIFICATE – I affirm that my statements contained in the complete application are true and correct to the best of my knowledge and belief.  Signed Mail Address 7733 Harwell St
City, State & Zip_Fort Worth, Texas 76108
Printed Michael A Hunter Phone 817-246-4848 Date 10/30/2014
OWNERS CERTIFICATE – I affirm that my statements contained in the complete application are true and correct to the best of my knowledge and belief.
Signed Meihau A. Flink Mail Address 7733 Harwell St
City, State & Zip_Fort Worth, Texas 76108
Printed Michael A. Hunter Phone 817-246-4848 Date 10/30/2014

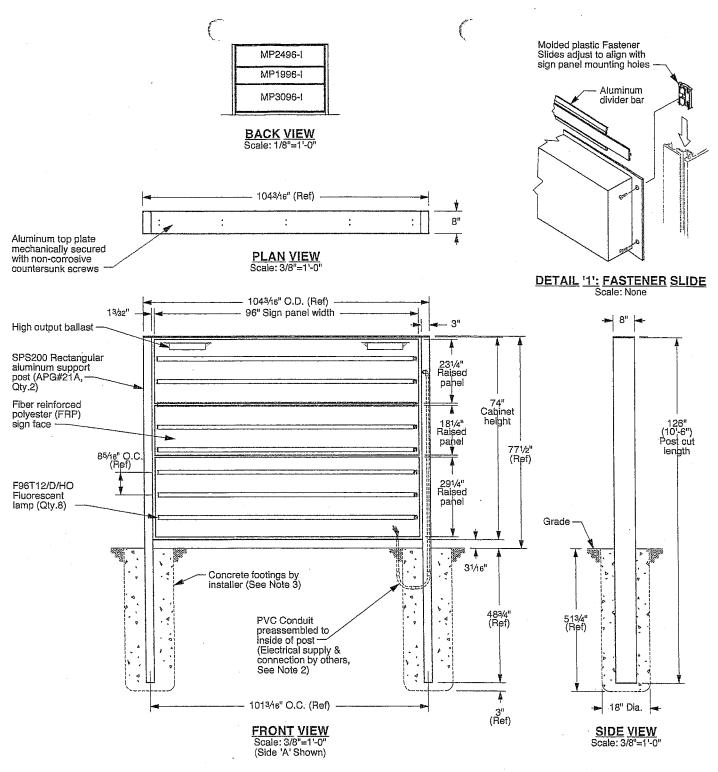

### NOTES:

1. Refer to presentation drawing and/or work order for colors, graphics specifications and

sign panel sizes.

2. \_\_\_V Electrical supply, conduit and associated fittings are by others. Installer to increase footing size as required to route conduit. Electrical connection performed by certified persons.

Footings are shown for reference only. Actual design and installation performed by certified persons based on local codes and geographic practices.

Lifting bolts are provided to assist with sign installation. Lifting brackets are accessible by removing post caps. Remove bolts after installation and replace post caps.

APPROVAL BY: . REQUIRED DATE:



Atlanta, Georgia USA • Phone: (404) 688-9000 • Web: www.apcosigns.com

All Design Rights Reserved

Customer: North Austin Medical Center Project: Exterior Main Entrance Location '11' - Elevation Views Product: 4420 MultiPanel PolySign

Product: Double Post Mount, Illuminated


Date: 10/01/14 Drawn: WWD Scale: As Shown Coord.: DTS W.O.#: 437581

Location(s)

11

Sheet: 11.a

Lifting bracket welded to vertical cabinet member (1 each end) 98 7/16" Cabinet width -4"x 4"x 1/4" x 1-15/16" Long structural aluminum angle welded into each corner 74" Cabinet housing (APG#405, full perimeter)

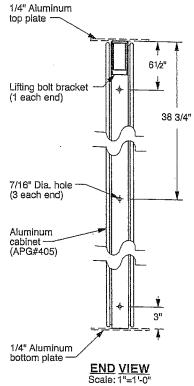

FRONT VIEW: SIGN CABINET
Scale: 1"=1'-0"

BOTTOM VIEW
Scale: 1"=1'-0" Weep hole (Qty.3)

Location(s)		
11		
1 1		

NOTES:

1. Refer to presentation drawing and/or work order for colors, graphics specifications and sign panel sizes.

APPROVAL BY: \_ REQUIRED DATE: \_



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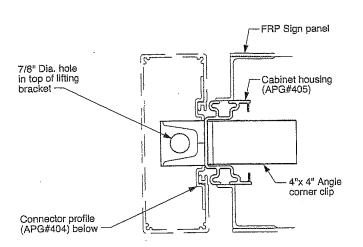
All Design Rights Reserved

Customer: North Austin Medical Center
Project: Exterior Main Entrance
Location '11' - Cabinet Details
Product: 4420 MultiPanel PolySign
Double Boot Mount Illuminate


Double Post Mount, Illuminated


Date: 10/01/14 Drawn: WWD Scale: As Shown Coord.: DTS W.O.#: 437581


Sheet: 11.b




## SECTION: "11.c1" Scale: 1/4"=1"

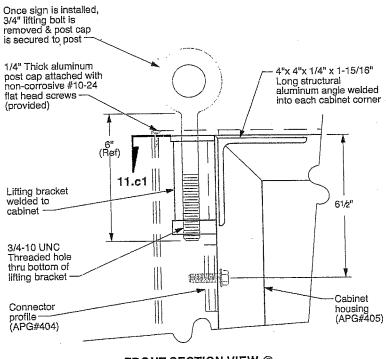

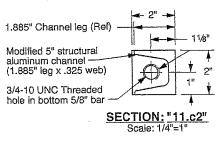

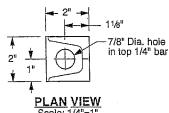

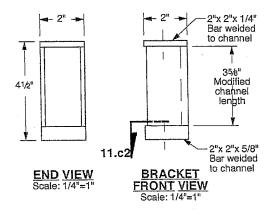

FRONT SECTION VIEW @ LIFTING BRACKET
Scale: 1/4"=1"

NOTES:

1. Lifting bolts are provided to assist with sign installation. Lifting brackets are accessible by removing post caps. In order to maintain structural integrity of the cabinet, use spreader beam and maintain a 90° angle between cabinet and both lifting bolts. Remove bolts after installation and replace post caps.

Location(s)

APPROVAL BY: — REQUIRED DATE:

Date: 10/01/14

DATE:



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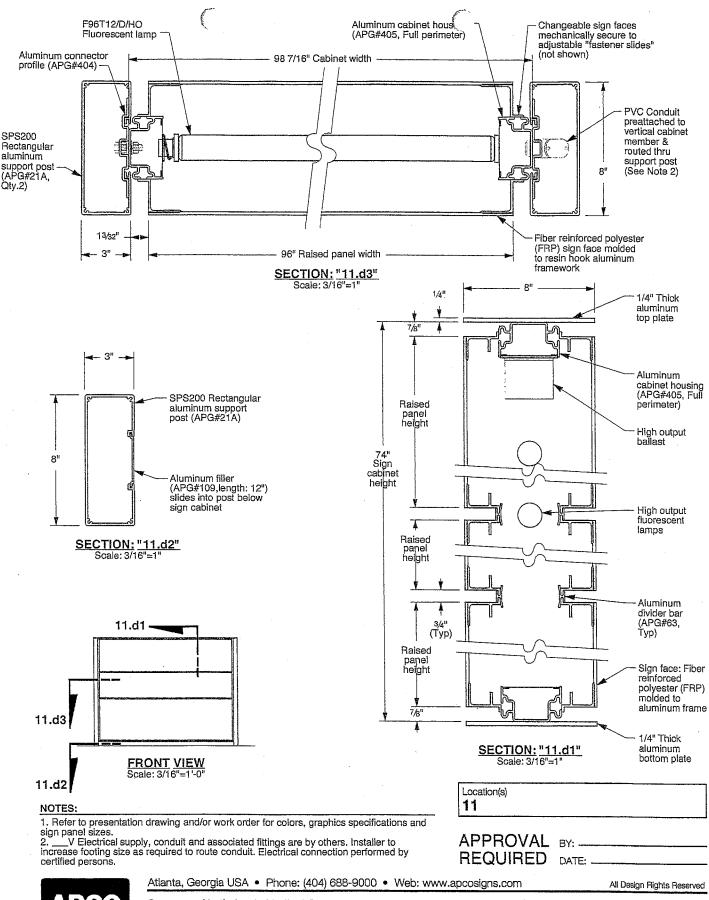
All Design Rights Reserved

Customer: North Austin Medical Center

Project: Exterior Main Entrance
Location '11' - Lifting Bracket Details
Product: 4420 MultiPanel PolySign
Double Post Mount, Illuminated

Drawn: WWD
Scale: As Shown
Coord.: DTS
W.O.#: 437581

Sheet: 11.c






Customer: North Austin Medical Center
Project: Exterior Main Entrance
Location '11' - Section Views
Product: 4420 MultiPanel PolySign
Double Post Mount, Illuminated


Date: 10/01/14 Drawn: WWD Scale: As Shown Coord.: DTS W.O.#: 437581


apcosigns.com

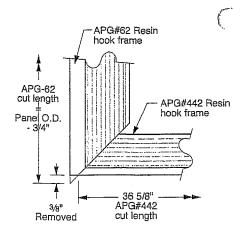

97 3/8" O.D. 96 5/8" (APG-442, cut length) APG#62 237/8" O.D. (24 5/8" Resin hook frame (Left & ÀPG#62 right sides) cut length) APG#442 Resin hook frame (Top & bottom) MP2496-I Scale: 3/4"=1'-0" (Qty.2, FRP not shown)

TYPICAL CORNER DETAIL

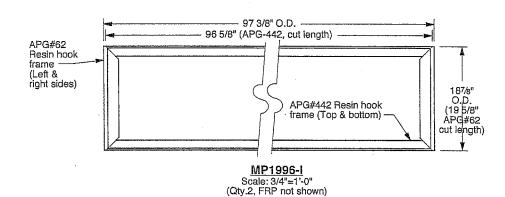

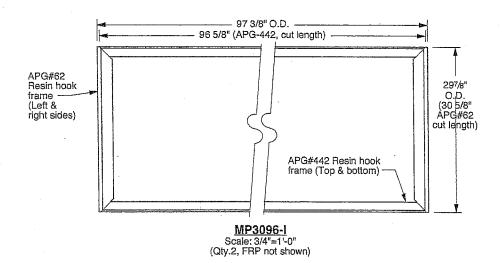

Location(s) 11

NOTES:

1. Refer to presentation drawing and/or work order for colors, graphics specifications and sign panel sizes.

APPROVAL BY: REQUIRED DATE:



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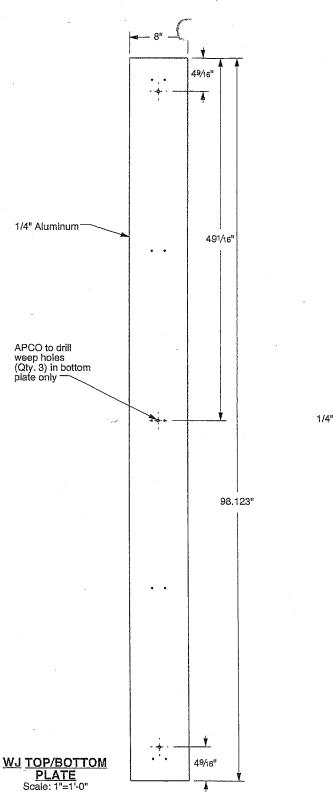
Project: Exterior Main Entrance
Location '11' - Section Views
Product: 4420 MultiPanel PolySign
Double Post Mount, Illuminated Product:


Customer: North Austin Medical Center

Date: 10/01/14 Drawn: WWD Scale: As Shown Coord.: DTS

W.O.#: 437581

Sheet: 11.e



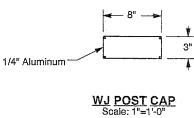

Location(s)
11

NOTES:

1. Refer to presentation drawing and/or work order for colors, graphics specifications and sign panel sizes.

APPROVAL BY: \_\_\_\_\_\_



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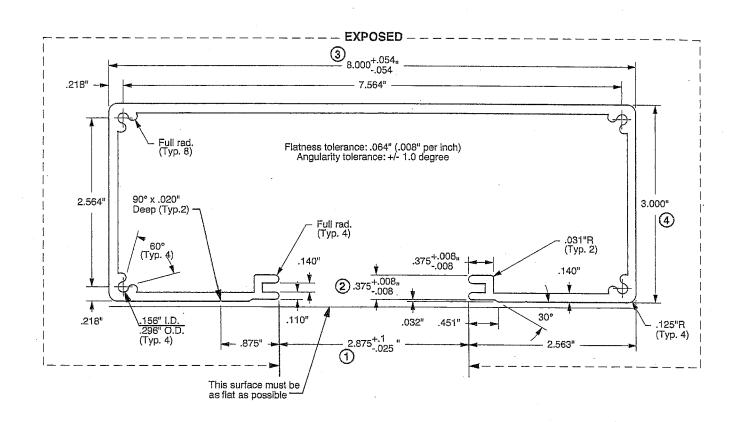
All Design Rights Reserved

Customer: North Austin Medical Center
Project: Exterior Main Entrance
Location '11' - Water-Jet Parts
Product: 4420 MultiPanel PolySign
Double Post Mount, Illuminated

Date: 10/01/14 Drawn: WWD Scale: As Shown Coord.: DTS W.O.#: 437581

apcosigns.com

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Revisions	Date	Check
Wall increased from .125" to	12/16/03	RCB
.140". Tolerance added &		
screwways changed from 90°		
to 60°		
Redrawn in Graphite	12/06/06	WWD



## APG#21A


Wt. Per Area	1.2
Perimeter	40.242
Area	2.753
Weight	3.303
Centroid X	-0
Centroid Y	.769
Inertia IXX	4.422
Inertia IYY	25.196
Inertia IXY	.001

Notes:
1. All design rights reserved.
2. All dimensions are in inches unless otherwise noted.
3. Numbered Bullets are Primary Inspected Areas.

## **APCO** Atlanta, Georgia USA • Phone: (404) 688-9000 • Web: www.apcosigns.com

Aluminum Assoc. Std. Tolerances Apply Unless Shown Otherwise			Solid ( ) Semi-Hollow ( )	Unspecified Corners	0.01 0.25		Тур. Wall Unless Noted	0.140" 3.56 <sub>mm</sub>		3/4" = 1"	Date 12/09/03		
Est. Area	2.753	Est. Weight	3.303 <sub>lbs./ft.</sub> 4.919 <sub>kg/m</sub>	Hollow I (X)		Alloy 6063	3-T5	Finish	Mill.	Die A	Active	Order S Code	SPS200
Est. Perimeter	40.242" <sub>Ext.</sub>	USA Stock Length	24'-1"	Drawn	JMM	Description Post 3" x 8" Rectangular APC			3- 21A				



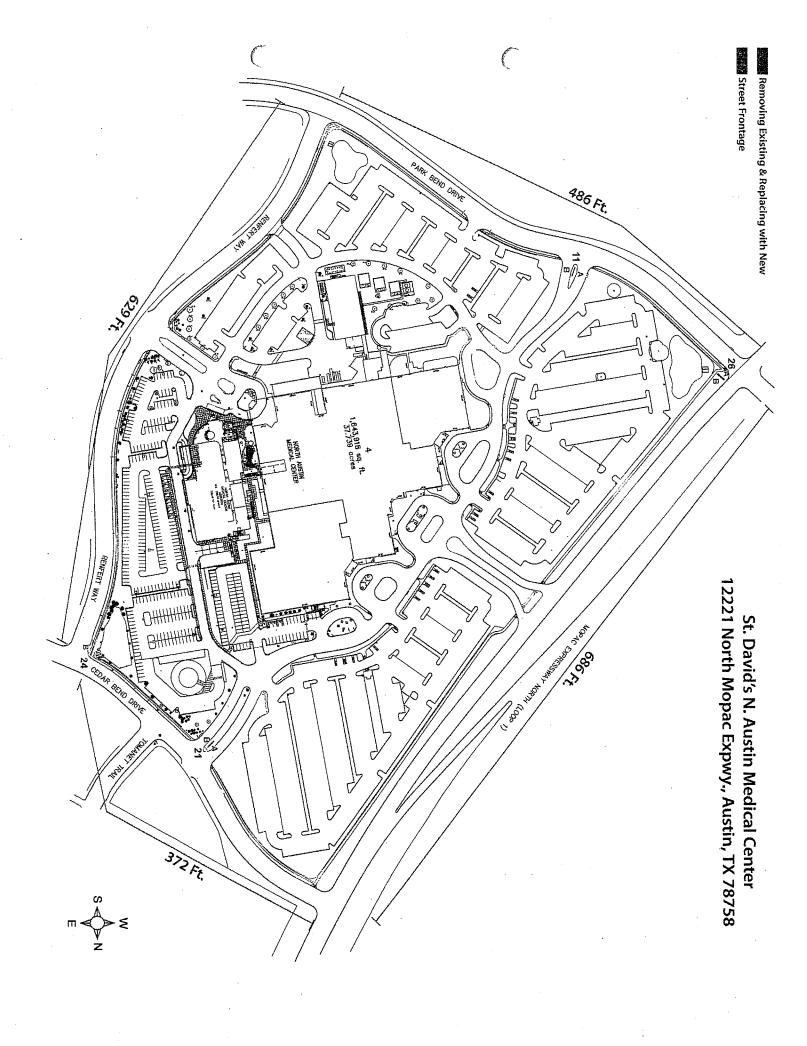







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CASE#_	'x' 0 \	

## CITY OF AUSTIN APPLICATION TO SIGN REVIEW BOARD SIGN VARIANCE

WARNING: Filing of this appeal stops all affected construction activity.

PLEASE: TYPE AND COMPLETE ALL REQUESTED INFORMATION.

STREET ADDRESS: 12221 N Mo-Pac Expressway Austin, TX 78758
LEGAL DESCRIPTION: Subdivision – 36.3670 A
Lot(s) 1 Block B Outlot Centrum Division The Resub of Blk B & E
I/We Michael A. Hunter on behalf of myself/ourselves as authorized agent for
St. David's North Austin Medical Center affirm that on October , 2014, hereby apply for a hearing before
the Sign Review Board for consideration:
ERECT - ATTACH - COMPLETE - REMODEL - MAINTAIN
Erect a new monument directional sign
in azoning district and located within the <u>Scenic Roadway</u> Sign District.

If your variance request is for a reduction in setbacks or height limits, please contact Eben Kellogg with the Electric Utility at (512)322-6050 and send him a scan of your request to <a href="mailto:eben.kellogg@austinenergy.com">eben.kellogg@austinenergy.com</a> before filing your application with this office to discuss your request. The Electric Utility will recommend the board deny your request if it will result in an encroachment into an electric easement or a NESC violation.

NOTE: The Board must determine the existence of, sufficiency of and weight of evidence supporting the findings described below. In order to grant your requeste for a variance, the Board must first make one or more of the findings described under 1, 2, and 3 below; the Board must then make the finding described in item 4 below. If the Board cannot make the required findings, it cannot approve a sign variance.

Therefore, you must complete each of the applicable Findings Statements as part of your application. Failure to do so may result in your application being rejected as incomplete. Please attach any additional support documents.

VARIANCE FINDINGS: I contend that my entitlement to the requested variance is based on the following findings: 1. The variance is necessary because strict enforcement of the Article prohibits any reasonable opportunity to provide adequate signs on the site, considering the unique features of a site such as its dimensions, landscaping, or topography, because: The new proposed sign is of the same type and design as previously approved signs for this property in Phase 1 approximately 2 years ago. OR, 2. The granting of this variance will not have a substantially adverse impact upon neighboring properties, because: We are replacing an existing sign of the same nature in the same location. OR, 3. The granting of this variance will not substantially conflict with the stated purposes of this sign ordinance, because: The additional size is needed to convey directions to various medical facilities within the campus AND, 4. Granting a variance would not provide the applicant with a special privilege not enjoyed by others similarly situated or potentially similarly situated, because: This is an emergency medical facility that needs to be able to convey directional information to those in need of emergency medical care. APPLICANT CERTIFICATE - I affirm that my statements contained in the complete application are true and correct to the best of my knowledge and belief. Mail Address 7733 Harwell St City, State & Zip Fort Worth, Texas 76108 Phone 817-246-4848 Date 10/30/2014 Printed Michael A Hunter OWNERS CERTIFICATE - I affirm that my statements contained in the complete application are true and correct to the best of my knowledge and belief. Mail Address 7733 Harwell St City, State & Zip Fort Worth, Texas 76108

Phone 817-246-4848 Date 10/30/2014

Printed Michael A. Hunter

ADDITIONAL INFORMATION TO BE SUBMITTED WITH COMPLETED APPLICATION: (FAILURE TO SUBMIT ALL THE REQUIRED MATERIALS WILL RESULT IN NON-ACCEPTANCE OF THE APPLICATION. BACKUP MATERIAL WILL BE ACCEPTED UNTIL 9:00 A.M. THE MONDAY PRIOR TO THE MEETING. THERE WILL BE NO EXCEPTIONS.)

SITE PLAN:

Must be drawn to scale, showing present and proposed construction and locations of existing structures on adjacent lots.

All Sign Review Board cases must submit location and elevation drawings, drawn to scale, in addition to the site plan required.

APPLICATION FEES: Residential

\$388.00

All Other


\$688.00


Please be advised that the Board can only hear 16 new cases per month, therefore, applications will be accepted on a first come, first served basis.

Please be advised that a request for reconsideration of any Board action must be filed within 10 days from the Board meeting/action.

If you need assistance completing this application (general inquires only) please contact: Leane Heldenfels, (512)974-2202, <a href="mailto:leane.heldenfels@austintexas.gov">leane.heldenfels@austintexas.gov</a> or Diana Ramirez, 974-2241, <a href="mailto:Diana.ramirez@austintexas.gov">Diana.ramirez@austintexas.gov</a> 505 Barton Springs Road, 1<sup>st</sup> floor, Development Assistance Center.

NOTE: ALL VARIANCES EXPIRE 1 YEAR (12 MONTHS) FROM DATE OF APPROVAL BY BOARD AS STATED IN SECTION 25-1-217 OF THE LAND DEVELOPMENT CODE UNLESS BOARD DECISION STATES OTHERWISE.

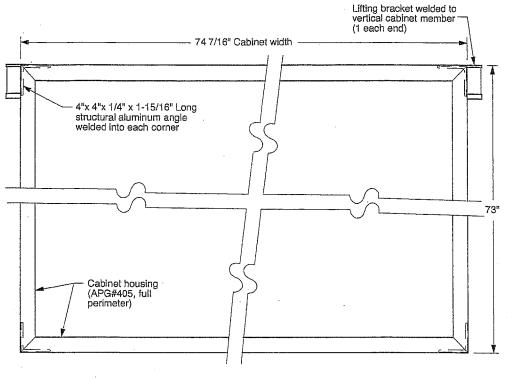

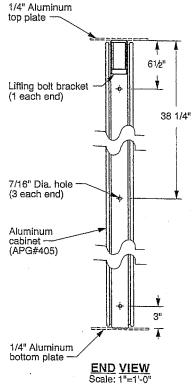

**BOTTOM VIEW** Weep hole (Qty.3) Scale: 1"=1'-0"

FRONT VIEW: SIGN CABINET
Scale: 1"=1'-0"

Location(s)			

NOTES:

1. Refer to presentation drawing and/or work order for colors, graphics specifications and sign panel sizes.

APPROVAL BY: REQUIRED DATE:

apcosigns.com


Atlanta, Georgia USA • Phone: (404) 688-9000 • Web: www.apcosigns.com

All Design Rights Reserved

Customer: North Austin Medical Center Project: Exterior Main Entrance
Location '21' - Cabinet Details
Product: 4420 MultiPanel PolySign
Double Post Mount, Illuminated

Date: 10/01/14 Drawn: WWD Scale: As Shown Coord: DTS W.O.#: 437581


Sheet: 21.b

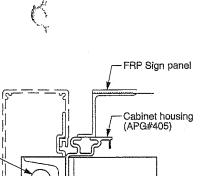


4"x 4" Angle

corner clip


SECTION: "21.c1" Scale: 1/4"=1"

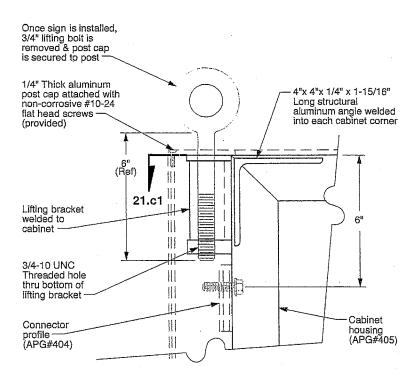

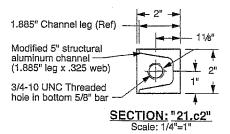

11/8" 7/8" Dia. hole in top 1/4" bar 2" 1"

**PLAN VIEW** Scale: 1/4"=1"

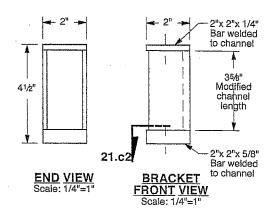

## Scale: 1/4"=1

NOTES:

Lifting bolts are provided to assist with sign installation. Lifting brackets are accessible
by removing post caps. In order to maintain structural integrity of the cabinet, use spreader
beam and maintain a 90° angle between cabinet and both lifting bolts. Remove bolts after
installation and replace post caps.

FRONT SECTION VIEW @ LIFTING BRACKET

> Location(s) 21

APPROVAL BY: -REQUIRED DATE:

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7/8" Dia. hole

in top of lifting

Connector profile (APG#404) below

bracket

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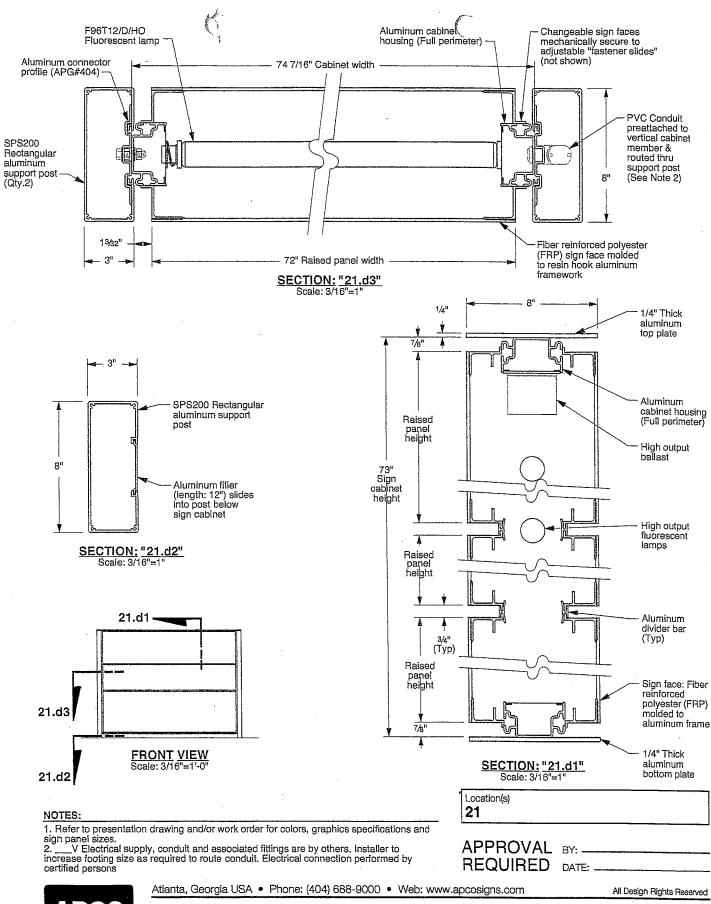
All Design Rights Reserved

Customer: North Austin Medical Center

Project: Exterior Main Entrance
Location '21' - Lifting Bracket Details
Product: 4420 MultiPanel PolySign
Double Post Mount, Illuminated Product:

Date: 10/01/14 Drawn: WWD Scale: As Shown Coord.: DTS W.O.#: 437581


Sheet: 21.c






Customer: North Austin Medical Center
Project: Exterior Main Entrance
Location '21' - Section Views
Product: 4420 MultiPanel PolySign
Double Post Mount, Illuminated

Date: 10/01/14 Drawn: WWD Scale: As Shown Coord.: DTS W.O.#: 437581

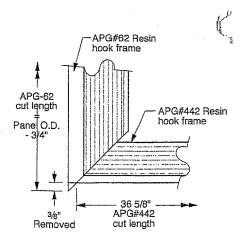


TYPICAL CORNER DETAIL
Scale: 1/4"=1"

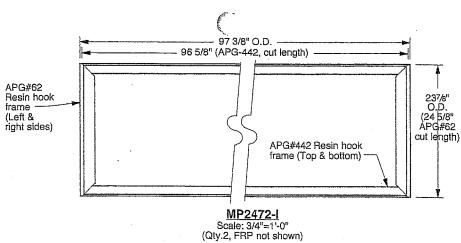

APG#62
Resin hook frame (Left & right sides)

MP1272-I
Scale: 3/4"=1'-0"
(Qty.2, FRP not shown)

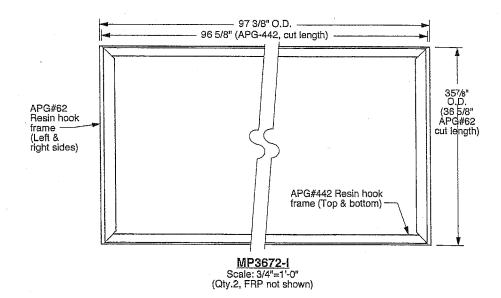

Location(s)	 		 
21		*	

NOTES:

1. Refer to presentation drawing and/or work order for colors, graphics specifications and sign panel sizes.

APPROVAL BY: \_\_ REQUIRED DATE: .

DATE: \_\_\_\_\_\_



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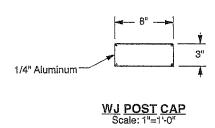
Customer: North Austin Medical Center Project: Exterior Main Entrance Location '21' - Section Views


Location '21' - Section Views
Product: 4420 MultiPanel PolySign
Double Post Mount, Illuminated

Drawn: WWD Scale: As Shown Coord.: DTS W.O.#: 437581

Date: 10/01/14

Sheet: 21.e



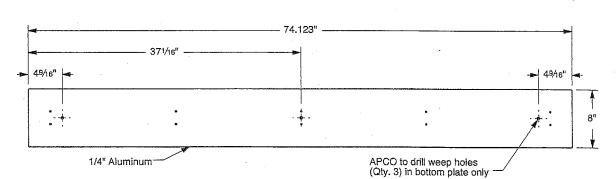

WJ TOP/BOTTOM PLATE Scale: 1"=1'-0"

Location(s)	 
21	

1. Refer to presentation drawing and/or work order for colors, graphics specifications and sign panel sizes.

APPROVAL BY: \_\_\_\_ REQUIRED DATE: \_



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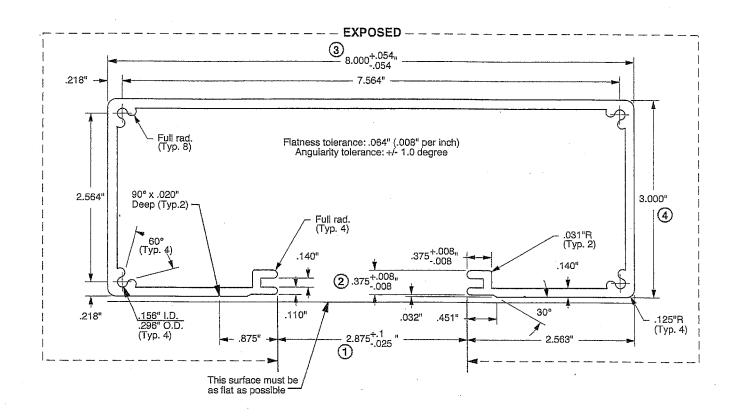
All Design Rights Reserved

Customer: North Austin Medical Center
Project: Exterior Main Entrance
Location '21' - Water-Jet Parts
Product: 4420 MultiPanel PolySign
Double Post Mount, Illuminated

Date: 10/01/14 Drawn: WWD Scale: As Shown Coord.: DTS W.O.#: 437581

Sheet: 21.f

		()
Revisions .	Date	Check
Wall increased from .125" to	12/16/03	RCB
.140", Tolerance added &		
screwways changed from 90°		
to 60°		
Redrawn in Graphite	12/06/06	WWD



## APG#21A

MA Day Avea	4.0
Wt. Per Area	1.2
Perimeter	40.242
Area	2,753
Weight	3.303
Centrold X	-0
Centroid Y	.769
Inertia IXX	4.422
Inertia IYY	25.196
Inertia IXV	001

Notes:
1. All design rights reserved.
2. All dimensions are in inches unless otherwise noted.
3. Numbered Bullets are Primary Inspected Areas.


## **APCO**

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			<del></del>											
	m Assoc. Std. nless Shown (			Solid Semi-Hollo	( ) w ( )	Unspecified Corners	0.010 0.25		Typ. Wali Unless Noted	0.140" 3.56 <sub>mm</sub>	Scale 3	3/4" = 1"	Date	12/09/03
Est. Area	2.753	Est. Weight	3.303 <sub>lbs./ft.</sub> 4.919 <sub>kg/m</sub>	Hollow I Hollow II	" (v)	Alloy 606	3-T5	Finish	Mill	Die A	ctive	Order S Code	SPS2	200
Est. Perimeter	40.242" <sub>Ext.</sub>	USA Stock Length	24'-1"	Drawn	JMM	Description	Pos	t 3" :	x 8" Rect	angular		APO	3- 2	1A

100 21

**EMIERGEN** 

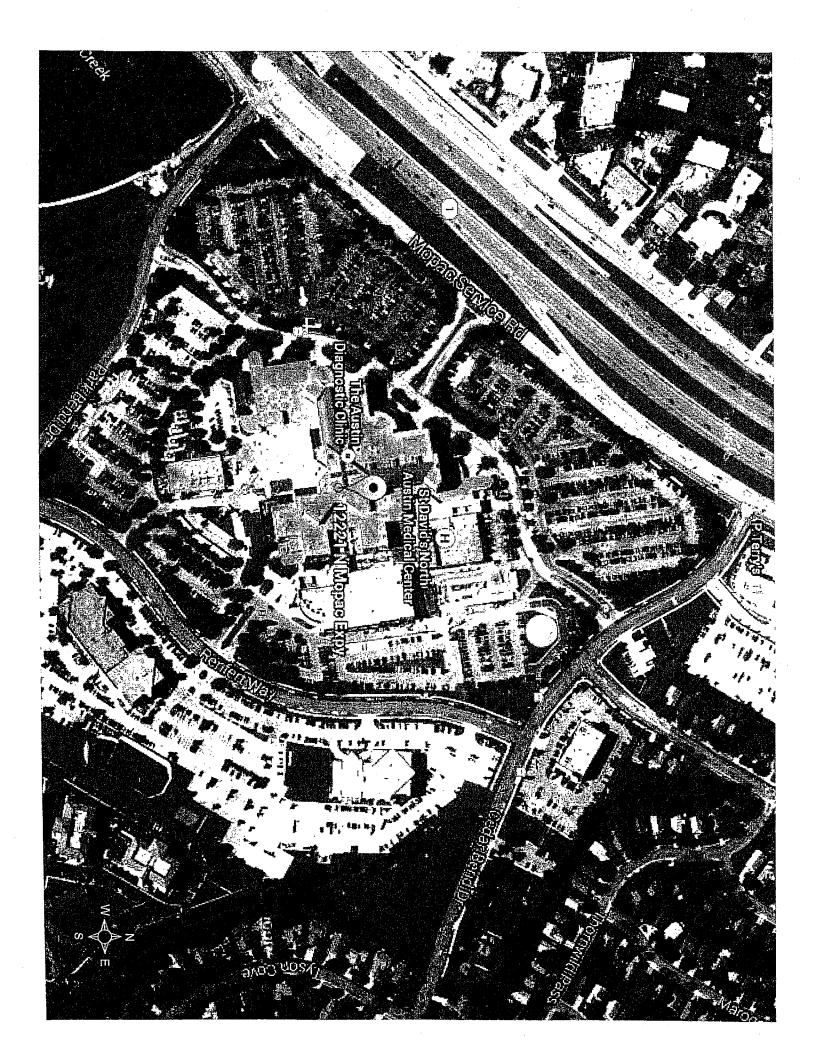

# CITY OF AUSTIN APPLICATION TO SIGN REVIEW BOARD SIGN VARIANCE

WARNING: Filing of this appeal stops all affected construction activity.

PLEASE: TYPE AND COMPLETE ALL REQUESTED INFORMATION.

STREET ADDRESS: 12221 N Mo-Pac Expressway Austin, TX 78758

LEGAL DESCRIPTION: Subdivision – 36.3670 A

Lot(s) 1 Block B Outlot Centrum Division The Result of Blk B & E

I/We Michael A. Hunter on behalf of myself/ourselves as authorized agent for

St. David's North Austin Medical Center affirm that on October , 2014, hereby apply for a hearing before the Sign Review Board for consideration:

ERECT – ATTACH – COMPLETE – REMODEL – MAINTAIN

Erect a new monument directional sign

in a \_\_\_\_\_\_\_ zoning district and located within the Scenic Roadway


Sign District.

If your variance request is for a reduction in setbacks or height limits, please contact Eben Kellogg with the Electric Utility at (512)322-6050 and send him a scan of your request to <a href="mailto:eben.kellogg@austinenergy.com">eben.kellogg@austinenergy.com</a> before filing your application with this office to discuss your request. The Electric Utility will recommend the board deny your request if it will result in an encroachment into an electric easement or a NESC violation.

NOTE: The Board must determine the existence of, sufficiency of and weight of evidence supporting the findings described below. In order to grant your requeste for a variance, the Board must first make one or more of the findings described under 1, 2, and 3 below; the Board must then make the finding described in item 4 below. If the Board cannot make the required findings, it cannot approve a sign variance.

Therefore, you must complete each of the applicable Findings Statements as part of your application. Failure to do so may result in your application being rejected as incomplete. Please attach any additional support documents.

VARIANCE FINDINGS: I contend that my entitlement to the requested variance is based on the following findings:						
1. The variance is necessary because strict enforcement of the Article prohibits any reasonable opportunity to provide adequate signs on the site, considering the unique features of a site such as its dimensions, landscaping, or topography, because: The new proposed sign is of the						
same type and design as previously approved signs for this property in Phase 1						
approximately 2 years ago.						
OR,						
2. The granting of this variance will not have a substantially adverse impact upon neighboring properties, because: We are replacing an existing sign of the same nature in the						
same location.						
OR,						
3. The granting of this variance will not substantially conflict with the stated purposes of this sign ordinance, because: The additional size is needed to convey directions to various						
medical facilities within the campus						
AND,						
4. Granting a variance would not provide the applicant with a special privilege not enjoyed by others similarly situated or potentially similarly situated, because: This is an emergency med-						
ical facility that needs to be able to convey directional information to those in need of emergency medical care.  APPLICANT CERTIFICATE – I affirm that my statements contained in the complete application are true and correct to the best of my knowledge and belief.  Signed Mail Address 7733 Harwell St						
City, State & Zip Fort Worth, Texas 76108						
Printed Michael A Hunter Phone 817-246-4848 Date 10/30/2014						
OWNERS CERTIFICATE – I affirm that my statements contained in the complete application are true and correct to the best of my knowledge and belief.						
Signed Muchael A. Hunter Mail Address 7733 Harwell St						
City, State & Zip_Fort Worth, Texas 76108						
Printed Michael A. Hunter Phone 817-246-4848 Date 10/30/2014						

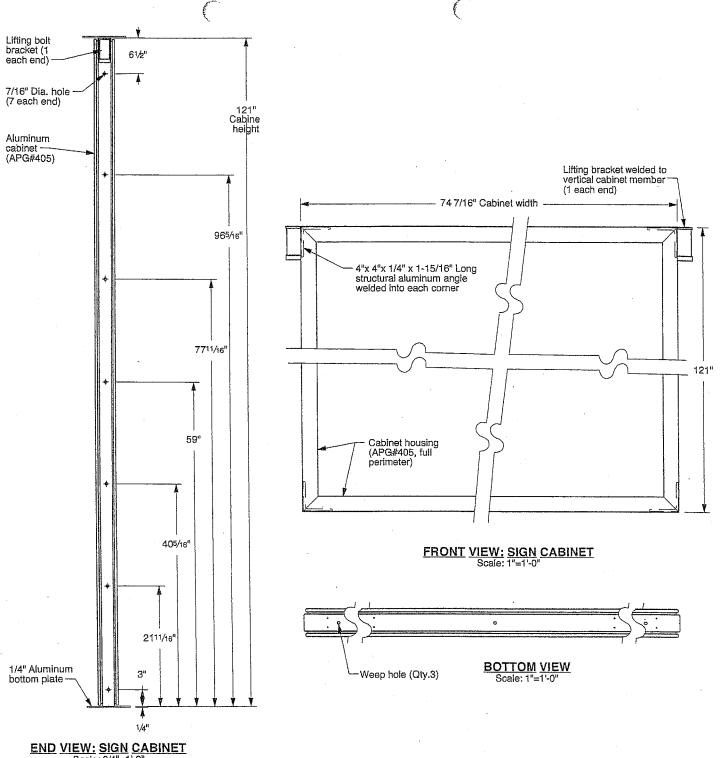

Scale: 3/4"=1'-0"
(Left end shown: Right end typical)

Location(s)
24

NOTES:

 Refer to presentation drawing and/or work order for colors, graphics specifications and sign panel sizes. APPROVAL BY: — REQUIRED DATE: -

DATE:



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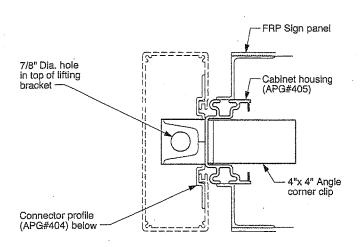
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Customer: North Austin Medical Center
Project: Exterior Main Entrance
Location '24' - Cabinet Details


Product: 4420 MultiPanel PolySign
Double Post Mount, Illuminated


Date: 10/01/14 Drawn: WWD Scale: As Shown Coord.: DTS W.O.#: 437581


Sheet: 24.b




### SECTION: "24.c1" Scale: 1/4"=1"

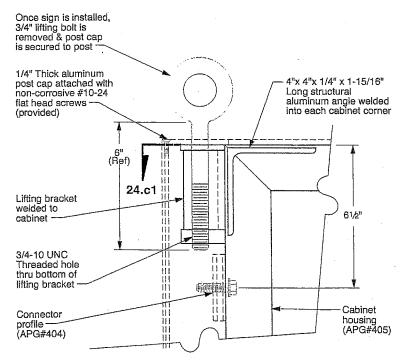

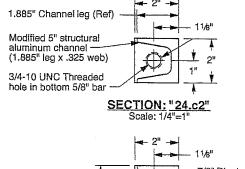

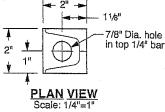

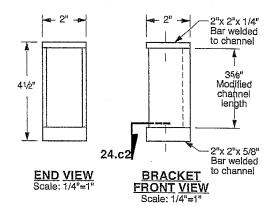

FRONT SECTION VIEW @ LIFTING BRACKET
Scale: 1/4"=1"

NOTES:

1. Lifting bolts are provided to assist with sign installation. Lifting brackets are accessible by removing post caps. In order to maintain structural integrity of the cabinet, use spreader beam and maintain a 90° angle between cabinet and both lifting bolts. Remove bolts after installation and replace post caps.

Location(s)	
24	

APPROVAL BY: \_\_\_\_\_\_



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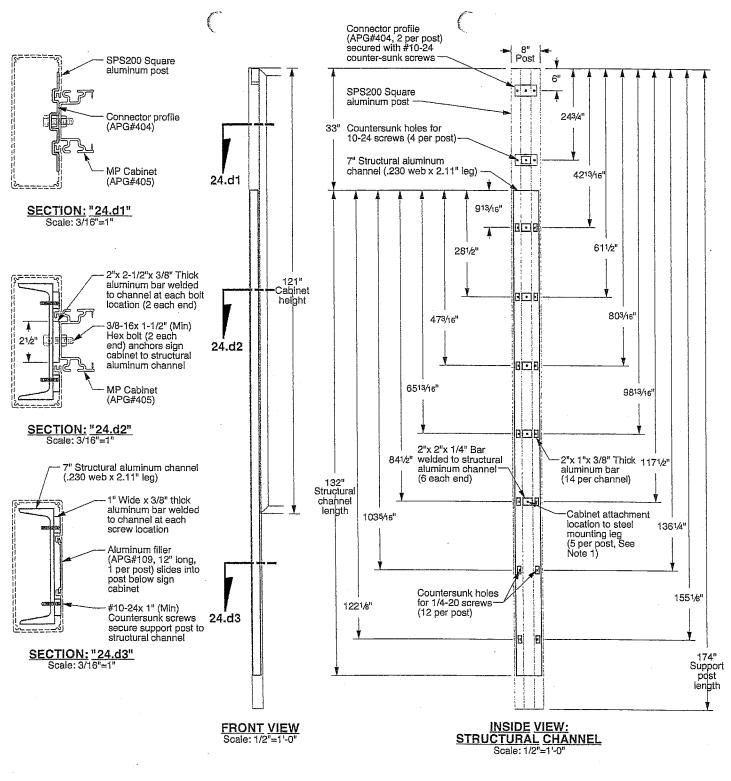
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Customer: North Austin Medical Center Project: Exterior Main Entrance

Location '24' - Lifting Bracket Details
Product: 4420 MultiPanel PolySign
Double Post Mount, Illuminated

Date: 10/01/14 Drawn: WWD Scale: As Shown Coord.: DTS W.O.#: 437581

Sheet: 24.c



NOTES:

1. Lifting bolts are provided to assist with sign installation. Lifting brackets are accessible by removing post caps. In order to maintain structural integrity of the cabinet, use spreader beam and maintain a 90° angle between cabinet and both lifting bolts. Remove bolts after installation and replace post caps.

Location(s) 24

APPROVAL BY: -REQUIRED DATE: \_

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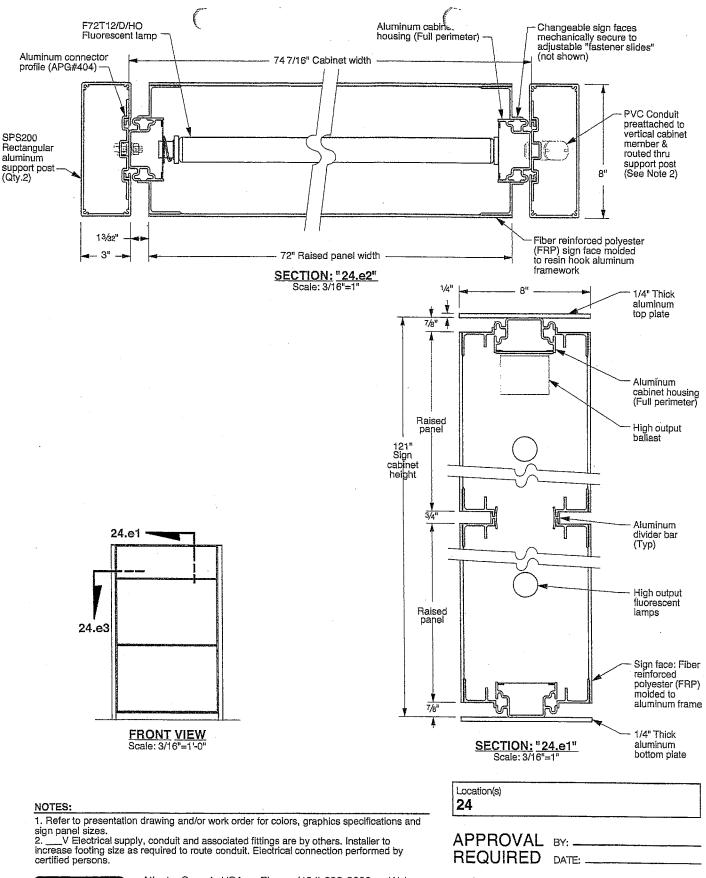
All Design Rights Reserved

Customer: North Austin Medical Center Project: Exterior Main Entrance

Location '24' - Structural Channel Details Product: 4420 MultiPanel PolySign Double Post Mount, Illuminated

Date: 10/01/14 Drawn: WWD Scale: As Shown Coord.: DTS W.O.#: 437581

Sheet: 24.d






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All Design Rights Reserved

Customer: North Austin Medical Center Project: Exterior Main Entrance

Location '24' - Section Views
Product: 4420 MultiPanel PolySign
Double Post Mount, Illuminated


Date: 10/01/14 Drawn: WWD Scale: As Shown Coord.: DTS W.O.#: 437581

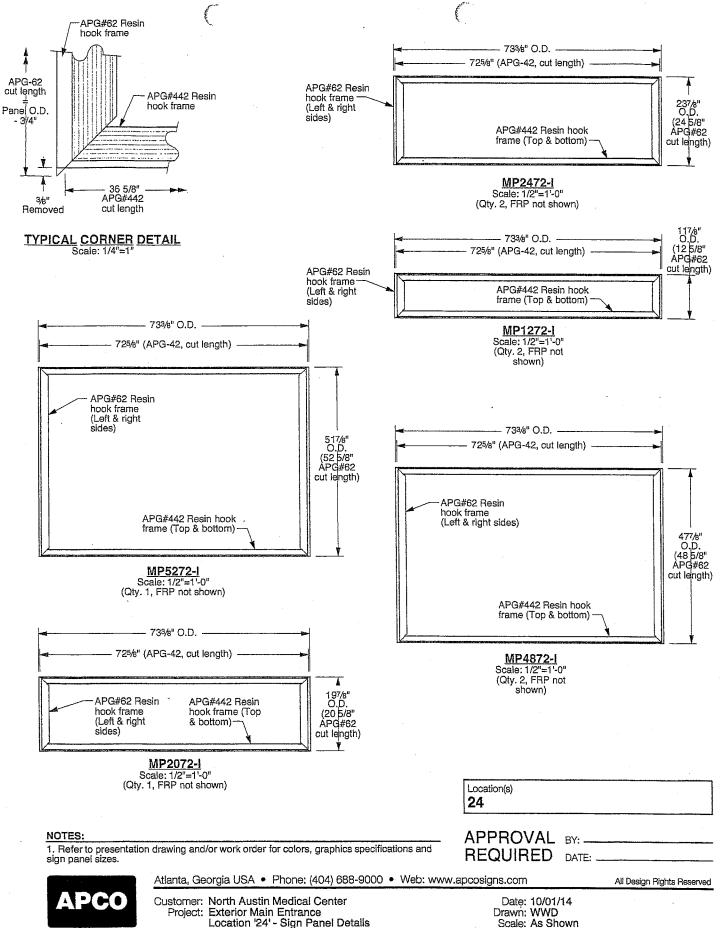


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Location '24' - Sign Panel Details
Product: 4420 MultiPanel PolySign
Double Post Mount, Illuminated Coord.: DTS W.O.#: 437581

Sheet: 24.f



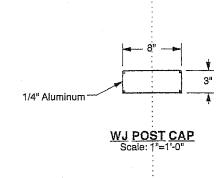

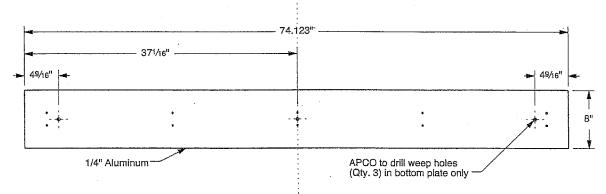WJ TOP/BOTTOM PLATE
Scale: 1"=1'-0"

Location(	s)

24

NOTES:

1. Refer to presentation drawing and/or work order for colors, graphics specifications and sign panel sizes.

APPROVAL BY: REQUIRED DATE: .




Atlanta, Georgia USA • Phone: (404) 688-9000 • Web: www.apcosigns.com


All Design Rights Reserved

Customer: North Austin Medical Center Project: Exterior Main Entrance Location '24' - Water-Jet Parts Product: 4420 MultiPanel PolySign Double Post Mount, Illuminated

Date: 10/01/14 Drawn: WWD Scale: As Shown Coord.: DTS W.O.#: 437581

Sheet: 24.g

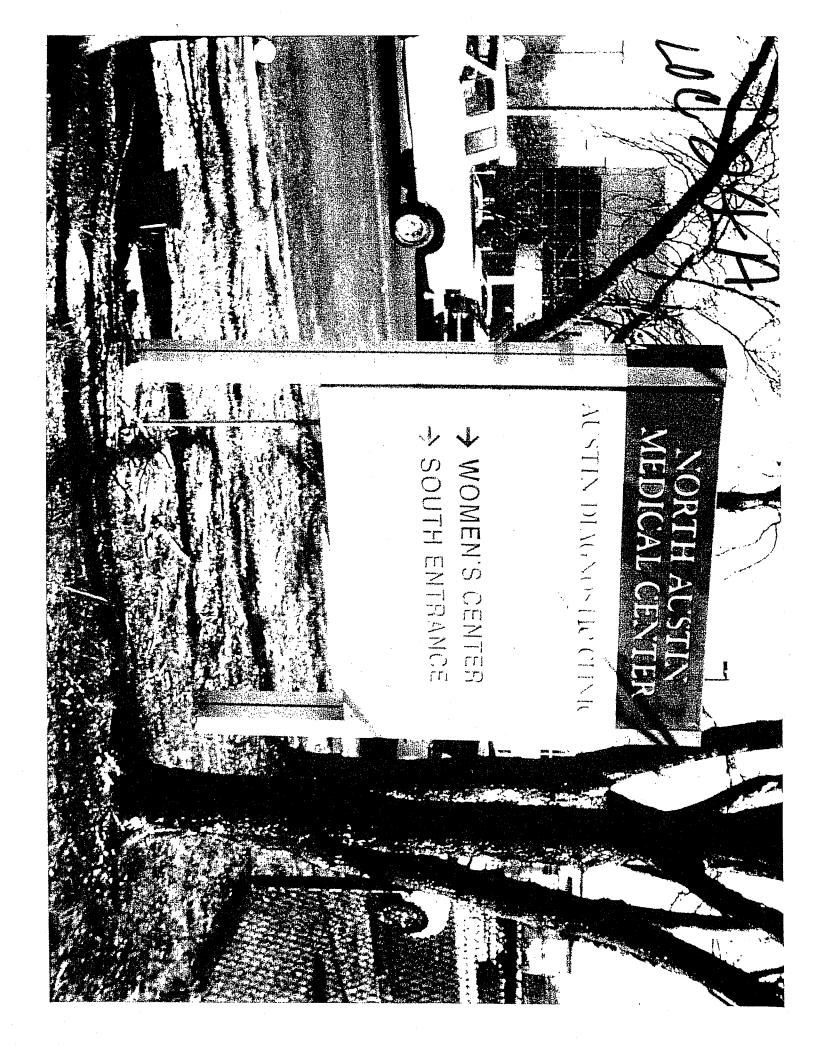

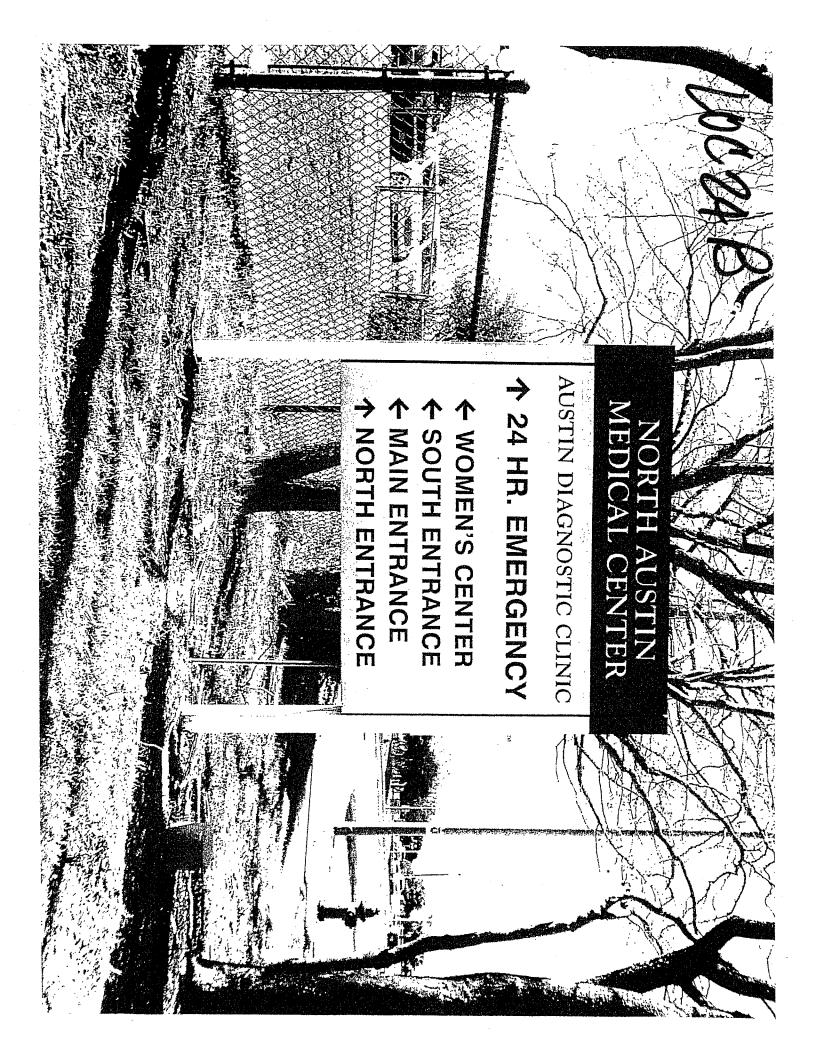



# 26

CASE # <u>C16-2015-000</u>]

CITY OF AUSTIN YOU APPLICATION TO SIGN REVIEW BOARD SIGN VARIANCE

TAX# 02601 30901

WARNING: Filing of this appeal stops all affected construction activity.


PLEASE: TYPE AND COMPLETE ALL REQUESTED INFORMATION.


STREET ADDRESS: 12221 N Mo-Pac Expressway Austin, TX 78758
LEGAL DESCRIPTION: Subdivision - 36.3670 A
Lot(s) 1 Block B Outlot Centrum Division The Resub of Blk B & E
I/We Michael A. Hunter on behalf of myself/ourselves as authorized agent for
St. David's North Austin Medical Center affirm that on October , 2014, hereby apply for a hearing before
the Sign Review Board for consideration:
ERECT - ATTACH - COMPLETE - REMODEL - MAINTAIN
Erect a new monument directional sign
in azoning district and located within the Scenic Roadway Sign District.

If your variance request is for a reduction in setbacks or height limits, please contact Eben Kellogg with the Electric Utility at (512)322-6050 and send him a scan of your request to <a href="mailto:eben.kellogg@austinenergy.com">eben.kellogg@austinenergy.com</a> before filing your application with this office to discuss your request. The Electric Utility will recommend the board deny your request if it will result in an encroachment into an electric easement or a NESC violation.


NOTE: The Board must determine the existence of, sufficiency of and weight of evidence supporting the findings described below. In order to grant your requeste for a variance, the Board must first make one or more of the findings described under 1, 2, and 3 below; the Board must then make the finding described in item 4 below. If the Board cannot make the required findings, it cannot approve a sign variance.

Therefore, you must complete each of the applicable Findings Statements as part of your application. Failure to do so may result in your application being rejected as incomplete. Please attach any additional support documents.

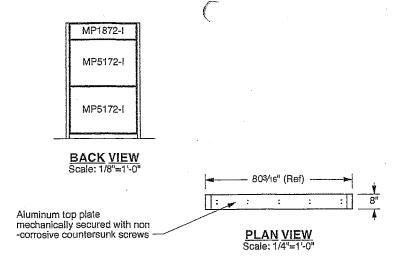

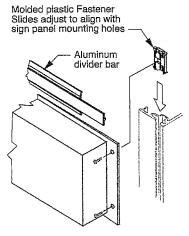

**DETAIL '1': FASTENER SLIDE** Scale: None

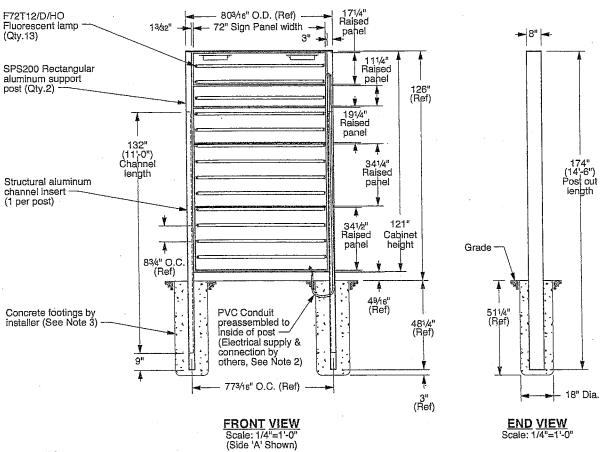

NOTES:

1. Refer to presentation drawing and/or work order for colors, graphics specifications and sign panel sizes. 2. \_\_\_V Electrics

2. \_\_\_V Electrical supply, conduit and associated fittings are by others. Installer to increase footing size as required to route conduit. Electrical connection performed by

octained persons.

3. Footings are shown for reference only. Actual design and installation performed by certified persons based on local codes and geographic practices.

4. Lifting bolts are provided to assist with sign installation. Lifting brackets are accessible by removing post caps. Remove bolts after installation and replace post caps.

Location(s) 26

APPROVAL BY: REQUIRED DATE: -



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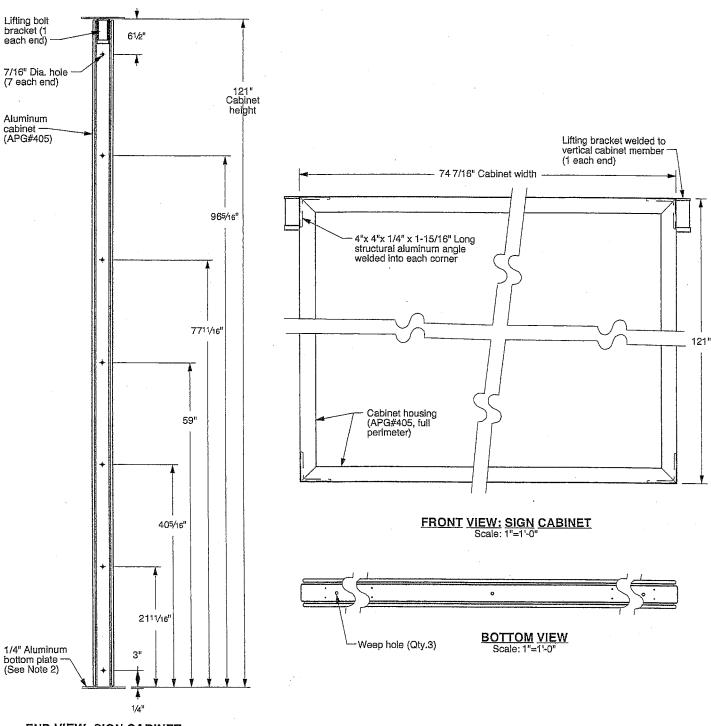
All Design Rights Reserved

Customer: North Austin Medical Center Project: Exterior Main Entrance Location '26' - Elevation Views

Product: 4420 MultiPanel PolySign
Double Post Mount, Illuminated

Date: 10/01/14 Drawn: WWD Scale: As Shown Coord.: DTS W.O.#: 437581

Sheet: 26.a



# END VIEW: SIGN CABINET Scale: 3/4"=1 '-0"

(Left end shown: Right end typical)

Location(s) 26

NOTES:

1. Refer to presentation drawing and/or work order for colors, graphics specifications and

APPROVAL BY: REQUIRED DATE: .



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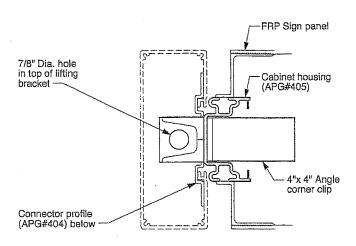
All Design Rights Reserved

Customer: North Austin Medical Center


Project: Exterior Main Entrance
Location '26' - Cabinet Details
Product: 4420 MultiPanel PolySign
Double Post Mount, Illuminated


Date: 10/01/14 Drawn: WWD Scale: As Shown Coord.: DTS W.O.#: 437581


Sheet: 26.b



# Scale: 1/4"=1"

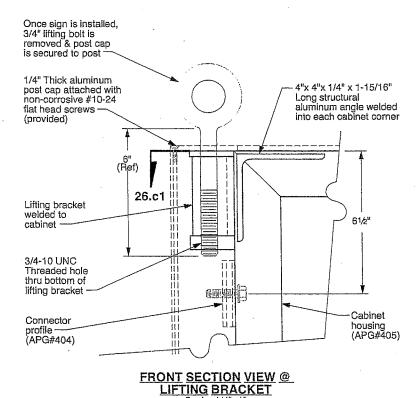

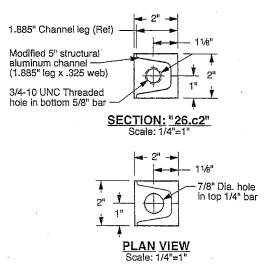

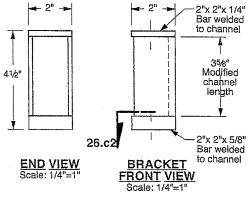

### NOTES:

1. Lifting bolts are provided to assist with sign installation. Lifting brackets are accessible by removing post caps. In order to maintain structural integrity of the cabinet, use spreader beam and maintain a 90° angle between cabinet and both lifting bolts. Remove bolts after installation and replace post caps.

Location(s)	 	
26		

APPROVAL BY: -REQUIRED DATE:



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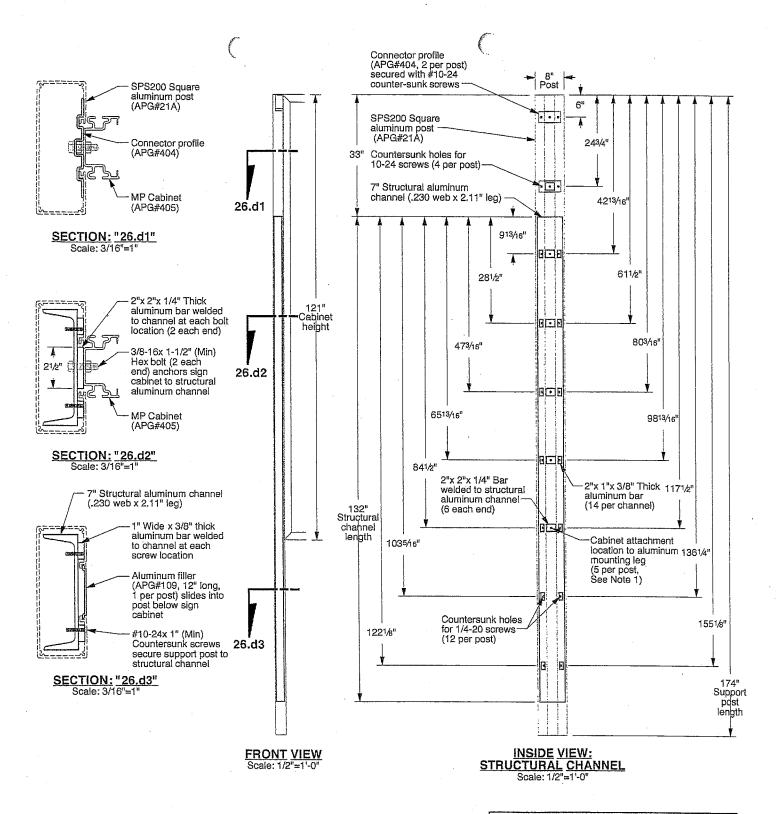
All Design Rights Reserved

Customer: North Austin Medical Center

Project: Exterior Main Entrance
Location '26' - Lifting Bracket Details
Product: 4420 MultiPanel PolySign
Double Post Mount, Illuminated

Date: 10/01/14 Drawn: WWD Scale: As Shown Coord.: DTS W.O.#: 437581

Sheet: 26.c



NOT	ES

1. Lifting bolts are provided to assist with sign installation. Lifting brackets are accessible by removing post caps. In order to maintain structural integrity of the cabinet, use spreader beam and maintain a 90° angle between cabinet and both lifting bolts. Remove bolts after installation and replace post caps.

Location(s)
26

APPROVAL BY: \_\_\_\_\_\_



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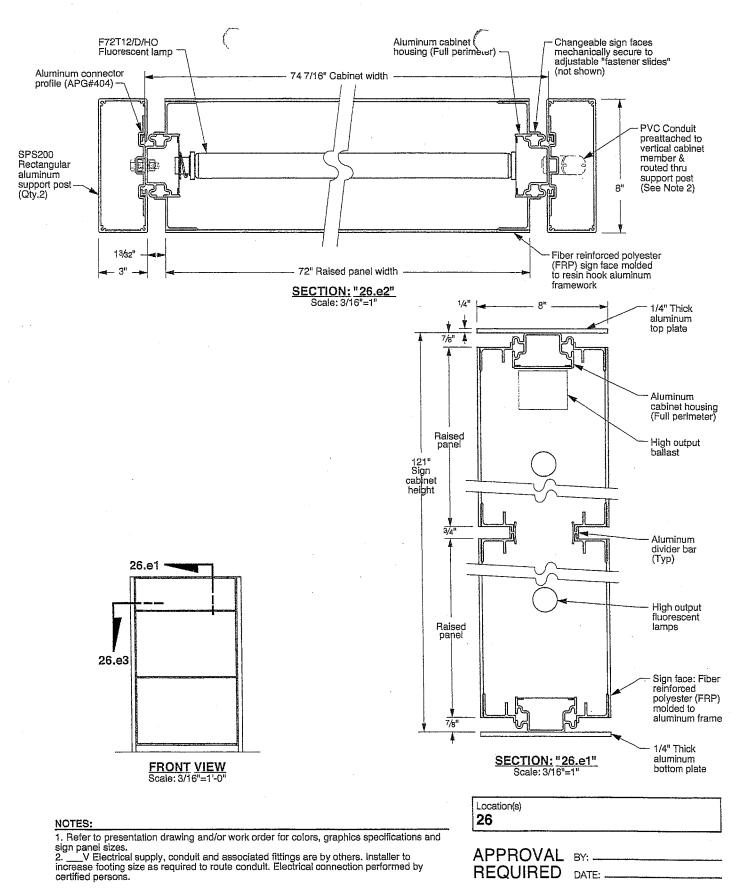
All Design Rights Reserved

Customer: North Austin Medical Center Project: Exterior Main Entrance

Location '26' - Structural Channel Details

Product: 4420 MultiPanel PolySign Double Post Mount, Illuminated Date: 10/01/14 Drawn: WWD Scale: As Shown Coord.: DTS W.O.#: 437581

Sheet: 26.d






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Customer: North Austin Medical Center Project: Exterior Main Entrance Location '26' - Section Views Product: 4420 MultiPanel PolySign Double Post Mount, Illuminated


Drawn: WWD Scale: As Shown Coord.: DTS W.O.#: 437581

Date: 10/01/14




Sheet: 26.f
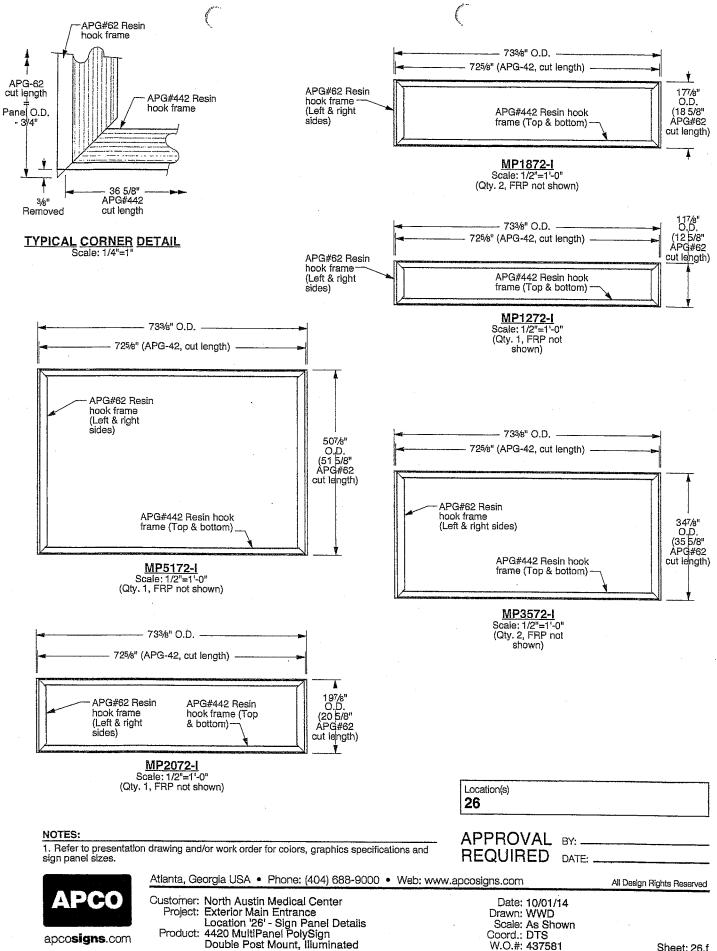
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#### WJ POST CAP Scale: 1"=1'-0"

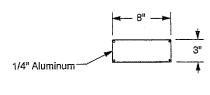

# WJ TOP/BOTTOM PLATE Scale: 1"=1'-0"

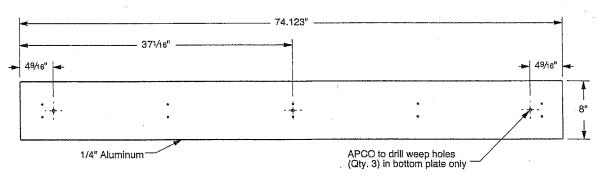		•	Location(s) 26	
NOTES:			APPROVAL REQUIRED	
1.	L.		NEWUINED	DATE:

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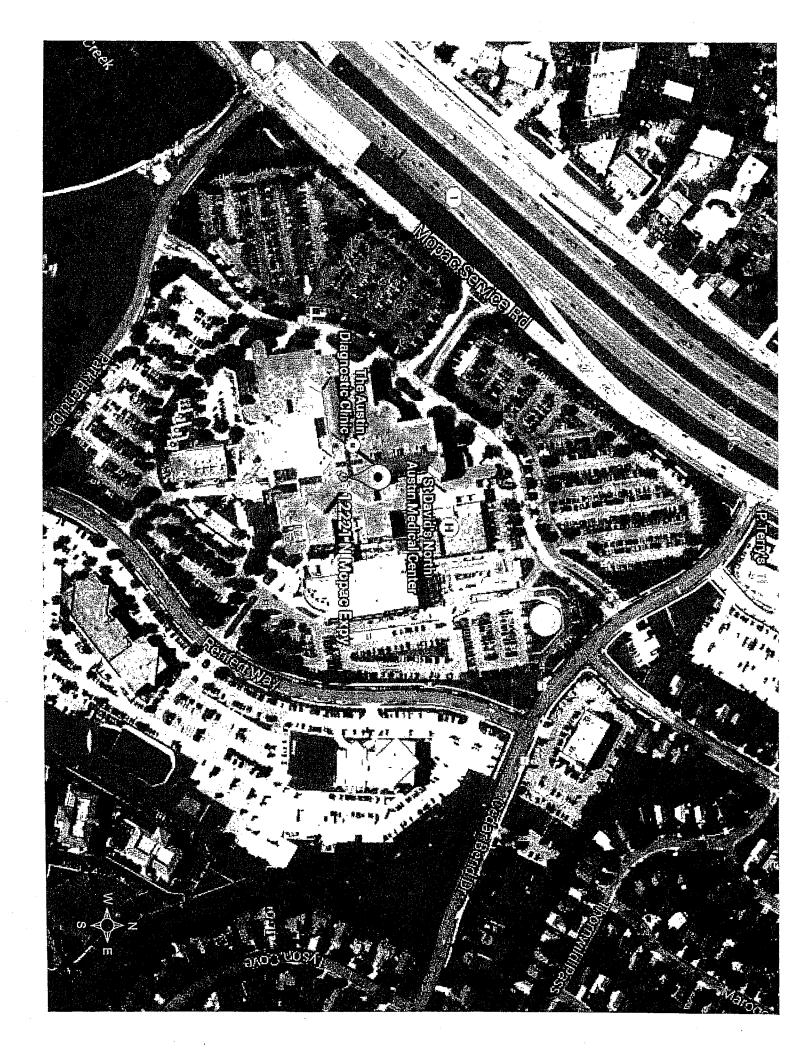
All Design Rights Reserved


Customer: North Austin Medical Center
Project: Exterior Main Entrance
Location '26' - Water-Jet Parts
Product: 4420 MultiPanel PolySign
Double Post Mount, Illuminated


Date: 10/01/14 Drawn: WWD Scale: As Shown Coord.: DTS W.O.#: 437581

Sheet: 26.g





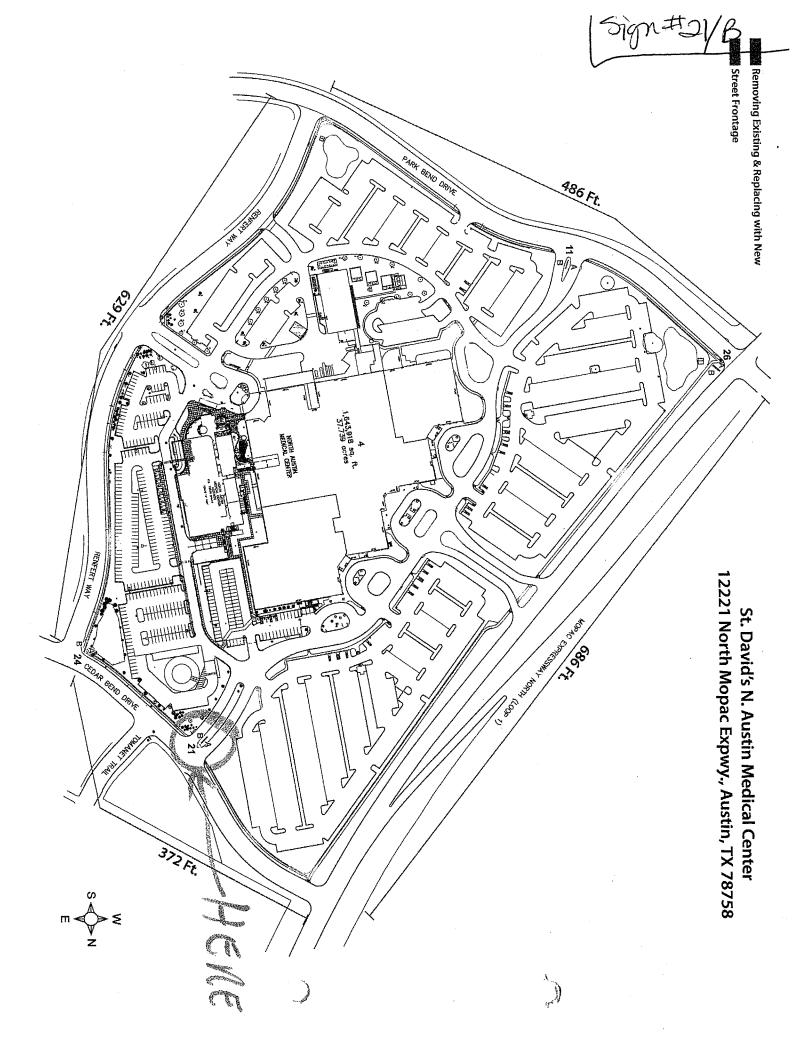

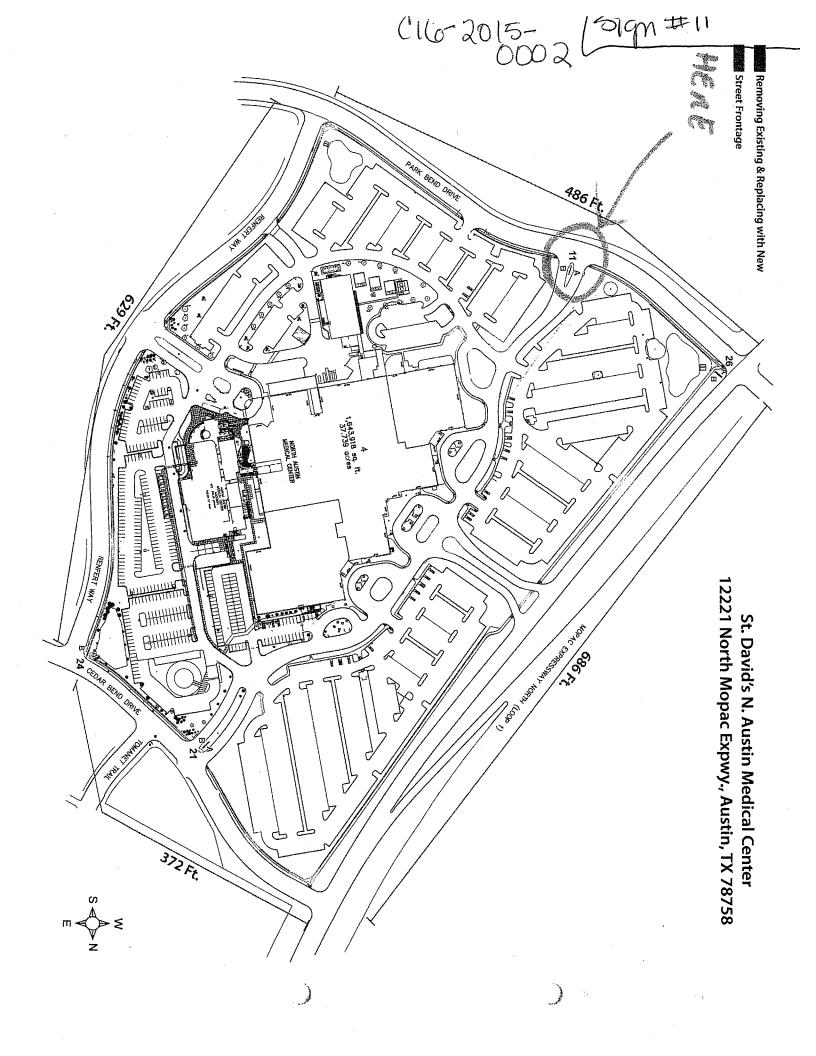

Fax 817-246-7583/Michael Honter

## Heldenfels, Leane

From:

Heldenfels, Leane

Sent:

Monday, December 22, 2014 12:47 PM

To:

'sales@huntercommercial.net'

Subject:

FW: 12221 N. Mopac

Hi Michael - see below from Sign Reviewer, Bryan Walker.

I was just confirming that we did actually have to go to BOA 1/12 since replacing like size, location and he advises we do so I am proceeding w/ the notices for the case.

But, could you confirm the info he asks below, and email revised drawing(s) to show these issues are addressed. Last day for revised drawings to be included in Board's advance packet will be end of day 1/31 to my email or mailbox - however if you could reply to this email and advise that we don't need variances to these issues and that you will be able to get the one sign out of the the PUE, then I won't add them to the notice language (if you advise the issues he raises can be resolved). My notices are due to be mailed 1/30 but I am getting them reviewed this week, so as soon as you can respond would be helpful.

Thanks -Leane Heldenfels Sign Review Board Liaison City of Austin

----Original Message-----From: Walker, Bryan

Sent: Tuesday, December 16, 2014 2:15 PM

To: Heldenfels, Leane Cc: Auzenne, Viktor

Subject: RE: 12221 N. Mopac

I think so since the existing signs are going to be removed entirely. I would like for the variance to specifically authorize the setback distances too. I didn't see any mention of that in the previous SRB applications. Currently, the signs are in conflict with the required 12'-0" setback (25-10-191(F) - and - 25-10-124(G)) from the Right-of-Way, and two of them appear to be located within the visibility triangle setback (25-10-23(B)(7)) that is required for signs installed on corners. In addition to that, the sign at location 26 is shown to be within the 7.5' PUE.

Bryar

AREVISE LOCCUTION, or ask for adolptional most move out of PUE.

----Original Message-----From: Heldenfels, Leane

Sent: Tuesday, December 16, 2014 12:25 PM

To: Auzenne, Viktor; Walker, Bryan

Subject: 12221 N. Mopac

This is a request for replacement of 4 directional signs (has an application for each - Sign #11, 21, 24 and 26. He said they were previously approved at these locations, sizes 2 years ago. Variances in '95 Does he need a new variance if replacing with like size, at same location just different message?

Thanks -Leane



## NOTICE OF PUBLIC HEARING LAND DEVELOPMENT CODE VARIANCE

Mailing Date: December 30, 2014 Case Number: C16-2015-0002

Please be advised that the City of Austin has received an application for a variance from the Land Development Code.

Applicant:	Michael Hunter, (817) 246-4848
Owner:	North Austin Medical Center, (512) 341-1000
Address:	12221 N. MOPAC EXPY

Variance Request(s): The applicant has requested a variance(s) to:

A.1. for sign 11, Section 25-10-124 (B) (1) (b) (Scenic Roadway Sign District Regulations) to increase the maximum area of a freestanding sign from 64 feet (required) to 90 feet (requested); and to A.2. for sign 11, Section 25-10-124 (F) (Scenic Roadway Sign District Regulations) to permit internal lighting of sign; and to A.3. for sign 11, Section 25-10-124 (G) (Scenic Roadway Sign District Regulations) to permit signs to be less than 12 feet from street right-of-way (required) to 11 feet from street right-of-way (requested); and to A.4. for sign 11, Section 25-10-191 (F) (Setback and Structural Requirements) a sign within 12 feet of street right-of-way must have either: 1) a height of not more than 30 inches; or 2) a clearance of nine feet (required) to 11 feet from street right-of-way, height of 77 inches and clearance of 7 inches (requested); and to A.5. for sign 11, Section 25-10-23 (B)(7)(Hazardous Signs Described and Prohibited) a person may not install, maintain or use a sign that has less than 9 feet of clearance and is located within a triangle formed by connecting the intersection point of two streets and the points 45 feet from the intersection point on the street frontage property line of each intersecting street (required) to 7 inches clearance and located within a triangle formed by connecting the intersection point of two streets and the points 26 feet from the intersection point on the street frontage property line of each intersecting street (requested); and to B.1. for sign 21, Section 25-10-124 (F) (Scenic Roadway Sign District Regulations) to permit internal lighting of sign; and to B.2. for sign 21, Section 25-10-124 (G) (Scenic Roadway Sign District Regulations) to permit signs to be less than 12 feet from street right-of-way (required) to 9 feet 9 inches from street right-of-way (requested); and to B.3. for sign 21, Section 25-10-191 (F) (Setback and Structural Requirements) a sign within 12 feet of street right-of-way must have either: 1) a height of not more than 30 inches; or 2) a clearance of nine feet (required) to 9 feet 9 inches from street right-of-way, height of 81 inches and clearance of 1 foot (requested); and to B.4. for sign 21, Section 25-10-23 (B)(7)(Hazardous Signs Described and Prohibited) a person may not install, maintain or use a sign that has less than 9 feet of clearance and is located within a triangle formed by connecting the intersection point of two streets and the points 45 feet from the intersection point on the street frontage property line of each intersecting street (required) to 7 inches clearance and located within a triangle formed by connecting the intersection point of two streets and the points 19 feet 9 inches from the intersection point on the street frontage property line of each intersecting street (requested); and to C.1. for sign 24, Section 25-10-124 (F) (Scenic Roadway Sign District Regulations) to permit internal lighting of sign; and to C.2. for sign 24, Section 25-10-124 (G) (Scenic Roadway Sign District Regulations) to permit signs to be less than 12 feet from street right-of-way (required) to 9 feet from street right-of-way (requested); and to C.3. for sign 24, Section 25-10-191 (F) (Setback and Structural Requirements) a sign within 12 feet of street right-of-way must have either: 1) a height of not more than 30 inches; or 2) a clearance of nine feet (required) to 9 feet from street right-of-way, height of 120 inches and clearance of 3 inches(requested); and to C.4. for sign 24, Section 25-10-23 (B)(7)(Hazardous Signs Described and Prohibited) a person may not install, maintain or use a sign that has less than 9 feet of clearance and is located within a triangle formed by connecting the intersection point of two streets and the points 45 feet from the intersection point on the street frontage property line of each intersecting street (required) to 3 innches of clearance and located within a triangle formed by connecting the intersection point of two streets and the points 19 feet from the intersection point on the street frontage property line of each intersecting street (requested); and to D.1. for sign 26, Section 25-10-124 (F) (Scenic Roadway Sign District Regulations) to permit internal lighting of sign; and to D.2. for sign 26, Section 25-10-124 (G) (Scenic Roadway Sign District Regulations) to permit signs to be less than 12 feet from street right-of-way (required) to 0 feet from street right-of-way (requested); and to D.3. for sign 26, Section 25-10-191 (F) (Setback and Structural Requirements) a sign within 12 feet of street right-of-way must have either: 1) a height of not more than 30 inches; or 2) a clearance of nine feet (required) to 0 feet from street right-of-way, height of 126 inches and clearance of 14 inches (requested); and to D.4. for sign 26, Section 25-10-23 (B)(7)(Hazardous Signs Described and Prohibited) a person may not install, maintain or use a sign that has less than 9 feet of clearance and is located within a triangle formed by connecting the intersection point of two streets and the points 45 feet from the intersection point on the street frontage property line of each intersecting street (required) to 14 inches clearance and located within a triangle formed by connecting the intersection point of two streets and the points 26 feet from the intersection point on the street frontage property line of each intersecting street (requested) provided new sign is moved out of public utility easement or License to Encroach into easement is obtained, in order to replace signs at same location as existing signs within this property in a Scenic Roadway District within a "PUD", Planned Unit Development zoning district.

This application is scheduled to be heard by the Sign Review Board on January 12th, 2015. The meeting will be held at City Council Chambers, 301 West 2<sup>nd</sup> Street beginning at 5:30 PM. You are being notified because City Ordinance requires that all property owners and utility account holders within 500 feet of the proposed development and affected neighborhood organizations be notified when an application is scheduled for a public hearing. You are not required to respond to this notice, however if you have any questions concerning this application, please contact Leane Heldenfels of the Planning and Development Review Department at 512-974-2202 or leane.heldenfels@austintexas.gov and refer to the Case Number at the top right of this notice. You may also find information on this case at our web site www.austintexas.gov/devreview/a\_queryfolder\_permits.jsp. If you do want to respond to this notice, please follow the directions provided on the following page. For additional information on the City of Austin's land development process, please visit our web site www.austintexas.gov/development.

# PUBLIC HEARING INFORMATION

Although applicants and/or their agent(s) are expected to attend a public hearing, you are not required to attend. However, if you do attend, you have the opportunity to speak FOR or AGAINST the proposed application. You may also contact a neighborhood or environmental organization that has expressed an interest in an application affecting your neighborhood.

During a public hearing, the board or commission may postpone or continue an application's hearing to a later date, or recommend approval or denial of the application. If the board or commission announces a specific date and time for a postponement or continuation that is not later than 60 days from the announcement, no further notice will be required.

A board or commission's decision may be appealed by a person with standing to appeal, or an interested party that is identified as a person who can appeal the decision. The body holding a public hearing on an appeal will determine whether a person has standing to appeal the decision.

An interested party is defined as a person who is the applicant or record owner of the subject property, or who communicates an interest to a board or commission by:

- delivering a written statement to the board or commission before or during the public hearing that generally identifies the issues of concern (it may be delivered to the contact person listed on a notice); or
- appearing and speaking for the record at the public hearing; and:
- occupies a primary residence that is within 500 feet of the subject property or proposed development;
- is the record owner of property within 500 feet of the subject property or proposed development; or
- is an officer of an environmental or neighborhood organization that has an interest in or whose declared boundaries are within 500 feet of the subject property or proposed development.

A notice of appeal must be filed with the director of the responsible department no later than 10 days after the decision. An appeal form may be available from the responsible department.

For additional information on the City of Austin's land development process, visit our web site: www.austintexas.gov/development.

Written comments must be submitted to the contact person listed on the notice before or at a public hearing. Your comments should include the name of the board or commission, or Council; the scheduled date of the public hearing; the Case Number; and the contact person listed on the notice. Any comments received will become part of the public record of the case.	listed on the notice de the name of the public hearing; the Any comments
Case Number: C16-2015-0002, 12221 N. Mopac Expy. Contact: Leane Heldenfels, 512-974-2202, leane.heldenfels@austintexas.gov Public Hearing: Sign Review Board, January 12th, 2015	Expy.  @austintexas.gov  h, 2015
Your Name (please print)	☐ I am in favor
Your address(es) affected by this application	
Signature Daytime Telephone:	Date
Comments:	
Note: all comments received will become part of the public record of this case	record of this case
If you use this form to comment, it may be returned to: City of Austin-Planning & Development Review Department/ 1st Floor Leane Heldenfels P. O. Box 1088 Austin, TX 78767-1088 Or scan and email to leane.heldenfels@austintexas.gov	l to: rtment/ 1st Floor '

# Fax 817-246-7583/Michael Horder

#### Heldenfels, Leane

From:

Heldenfels, Leane

Sent;

Monday, December 22, 2014 12:47 PM

To:

'sales@huntercommercial.net'

Subject

FW: 12221 N. Mopac

HI Michael - see below from Sign Reviewer, Bryan Walker.

I was just confirming that we did actually have to go to BOA 1/12 since replacing like size, location and he advises we do so I am proceeding w/ the notices for the case.

But, could you confirm the info he asks below, and email revised drawing(s) to show these issues are addressed. Last day for revised drawings to be included in Board's advance packet will be end of day 1/31 to my email or mailbox however if you could reply to this email and advise that we don't need variances to these issues and that you will be able to get the one sign out of the the PUE, then I won't add them to the notice language (if you advise the issues he raises can be resolved). My notices are due to be mailed 1/30 but I am getting them reviewed this week, so as soon as you can respond would be helpful.

Thanks -Leane Heldenfels Sign Review Board Liaison

City of Austin

----Original Message-----From: Walker, Bryan

Sent: Tuesday, December 16, 2014 2:15 PM

To: Heldenfels, Leane Cc: Auzenne, Viktor

Subject; RE: 12221 N. Mopac

I think so since the existing signs are going to be removed entirely. I would like for the variance to specifically authorize the setback distances too. I didn't see any mention of that in the previous SRB applications. Currently, the signs are in conflict with the required 12'-0" setback (25-10-191(F) - and - 25-10-124(G)) from the Right-of-Way, and two of them appear to be located within the visibility triangle setback (25-10-23(B)(7)) that is required for signs installed on corners. ARRUISe location, or osle for adolational variances.

Most move out of PUE. In addition to that, the sign at location 26 is shown to be within the 7.5' PUE.

----Original Message---

From: Heldenfels, Leane Sent: Tuesday, December 16, 2014 12:25 PM

To: Auzenne, Viktor; Walker, Bryan

Subject: 12221 N. Mopac

This is a request for replacement of 4 directional signs (has an application for each - Sign #11, 21, 24 and 26. He said they were previously approved at these locations, sizes 2 years ago. Variances in '95 Does he need a new variance if replacing with like size, at same location just different message?

Leane

OK -- V.17 AM31

8172467583

14400

SCAN T4073

Status

Station Name/Number

pəəds

геидси

# dol

Type

Time

Date

12129749109

Friday, 2014-12-26 14:45

OFG-175

# Transmission Log

FOR File

#### Heldenfels, Leane

From:

Walker, Bryan

Sent:

Tuesday, December 16, 2014 2:15 PM

To:

Heldenfels, Leane

Cc: Subject: Auzenne, Viktor RE: 12221 N. Mopac

I think so since the existing signs are going to be removed entirely. I would like for the variance to specifically authorize the setback distances too. I didn't see any mention of that in the previous SRB applications. Currently, the signs are in conflict with the required 12'-0" setback (25-10-191(F) - and - 25-10-124(G)) from the Right-of-Way, and two of them appear to be located within the visibility triangle setback (25-10-23(B)(7)) that is required for signs installed on corners. In addition to that, the sign at location 26 is shown to be within the 7.5' PUE.

#### Bryan

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Sent: Tuesday, December 16, 2014 12:25 PM

To: Auzenne, Viktor; Walker, Bryan

Subject: 12221 N. Mopac

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Thanks -Leane

----Original Message-----

From: OTC010lmosPark [mailto:OTC010lmosPark@austintexas.gov]

Sent: Tuesday, December 16, 2014 12:09 PM

To: Heldenfels, Leane

Subject: Scan from a Xerox WorkCentre OTC010lmosPark


Please open the attached document. It was scanned and sent to you using a Xerox WorkCentre.


Number of Images: 61 Attachment File Type: PDF


Device Name: OTC010lmosPark

Device Location:

For more information on Xerox products and solutions, please visit <a href="http://www.xerox.com/">http://www.xerox.com/</a>

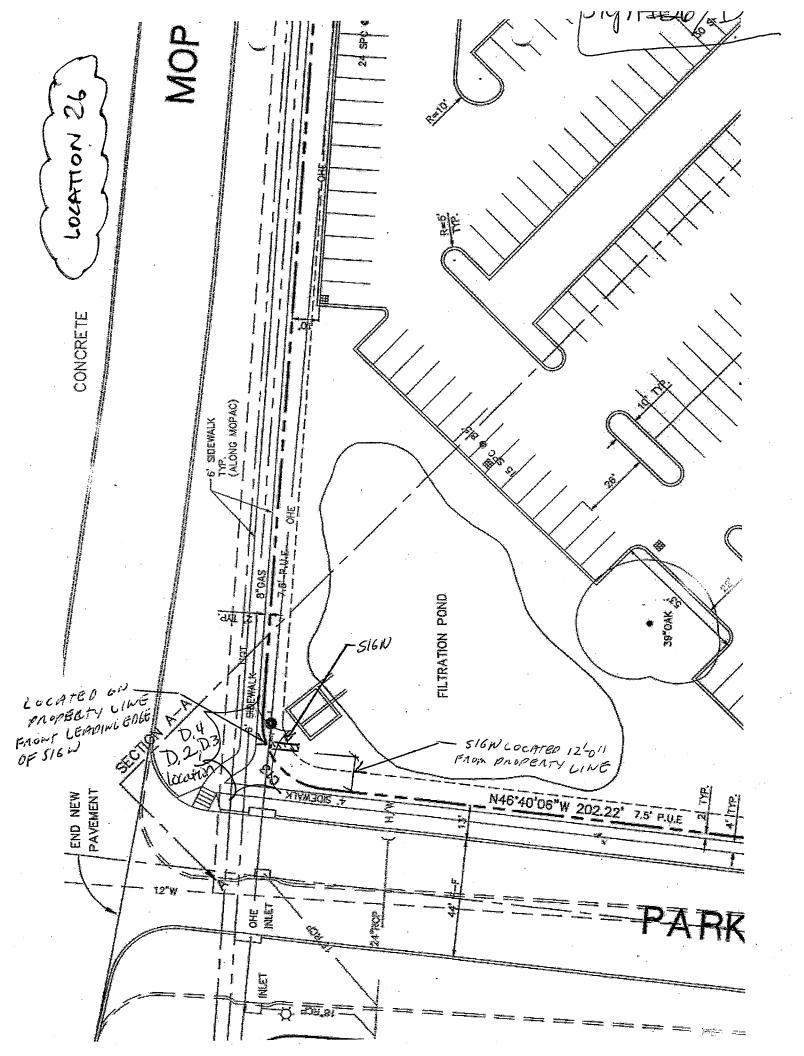

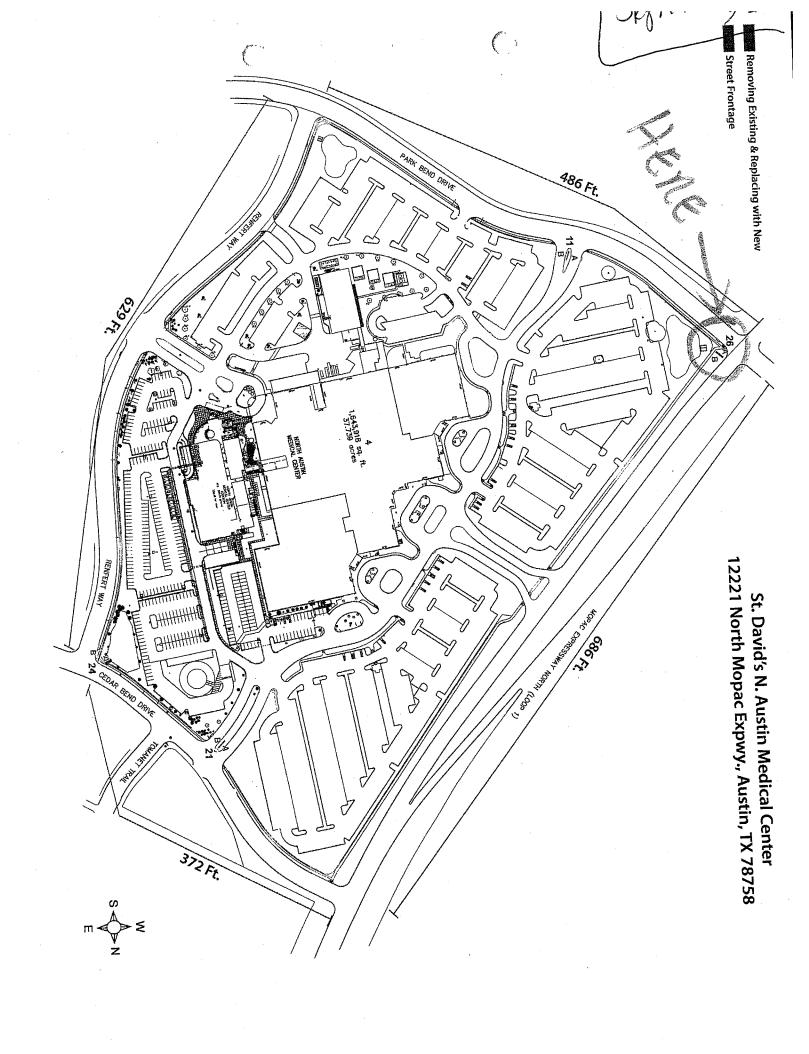

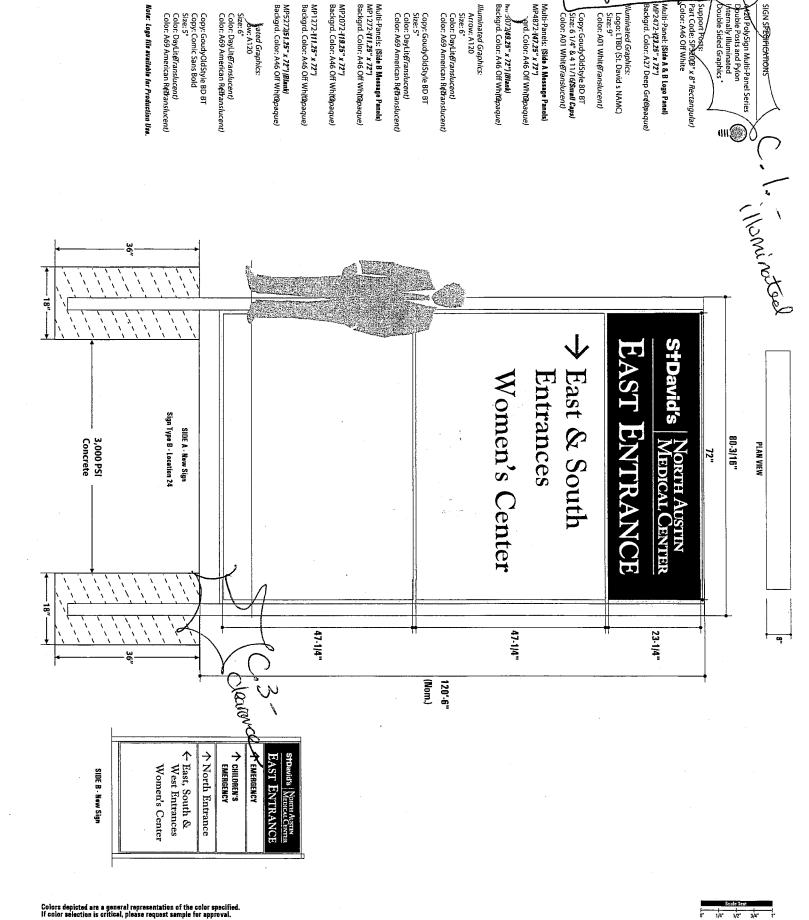



Arrow: A120


**APCO** 


Corporate Headquarters 388 Grant Street SE Atlanta, GA 30312-2227 Ph: 404.688.9000, Fax: 404.577.3B47 apcosigns.com Email: sales@apcosigns.com


Project Heler	ence;	Same	Date:	Drawn By	Production laip:	Sign Type
Project:	Children's EMERGENCY - North Austin Med. Ctr.	Draft Revision Revision	19, May 2014 12, June 2014 13, June 2014	RHK RHK RHK	Work Order #BD Approved By:	B Location 24
Sales Rep: CSR/PM:	Diana Barcafar	Revision Revision Revision	18, July 2014 25, Aug. 2014 27, Aug. 2014	RHK RHK RHK	Approved Date:  Customer approval is required prior to production	4420 PolySign Series n.Scale: 1/2" = 1 -0"

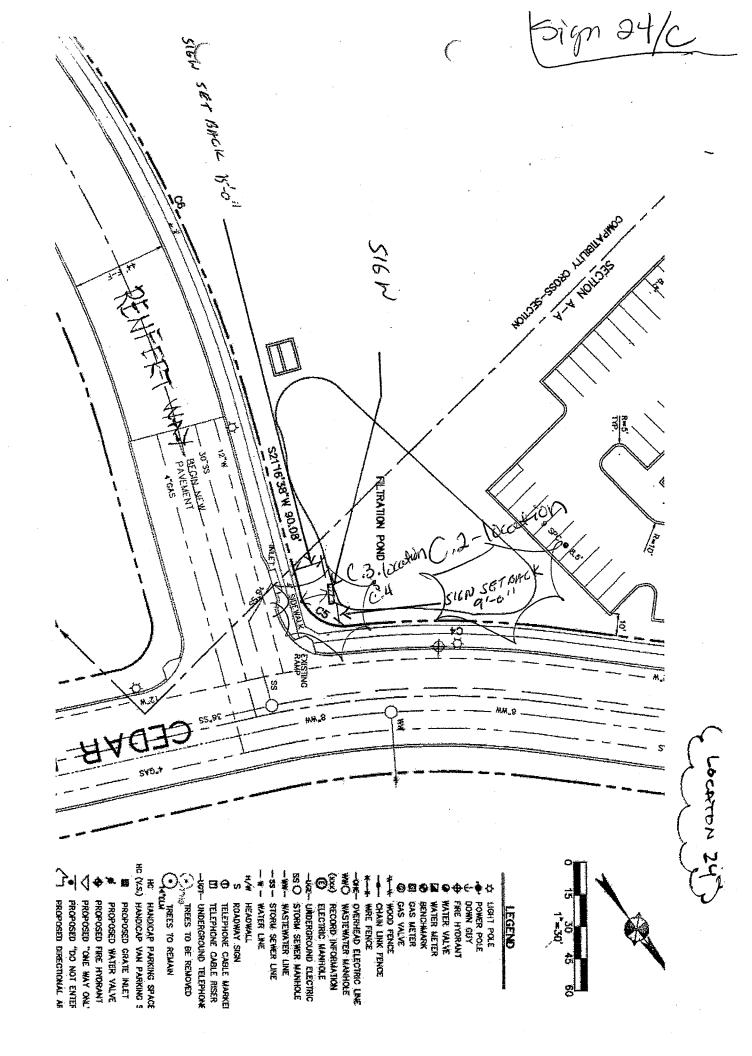

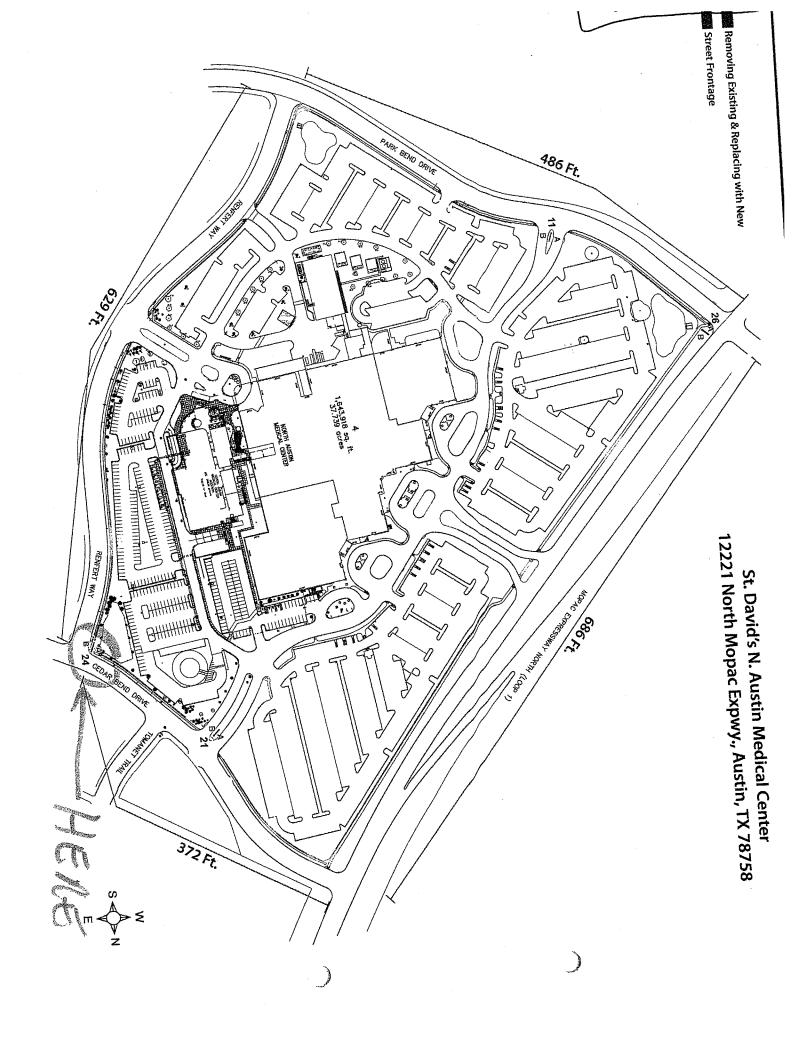

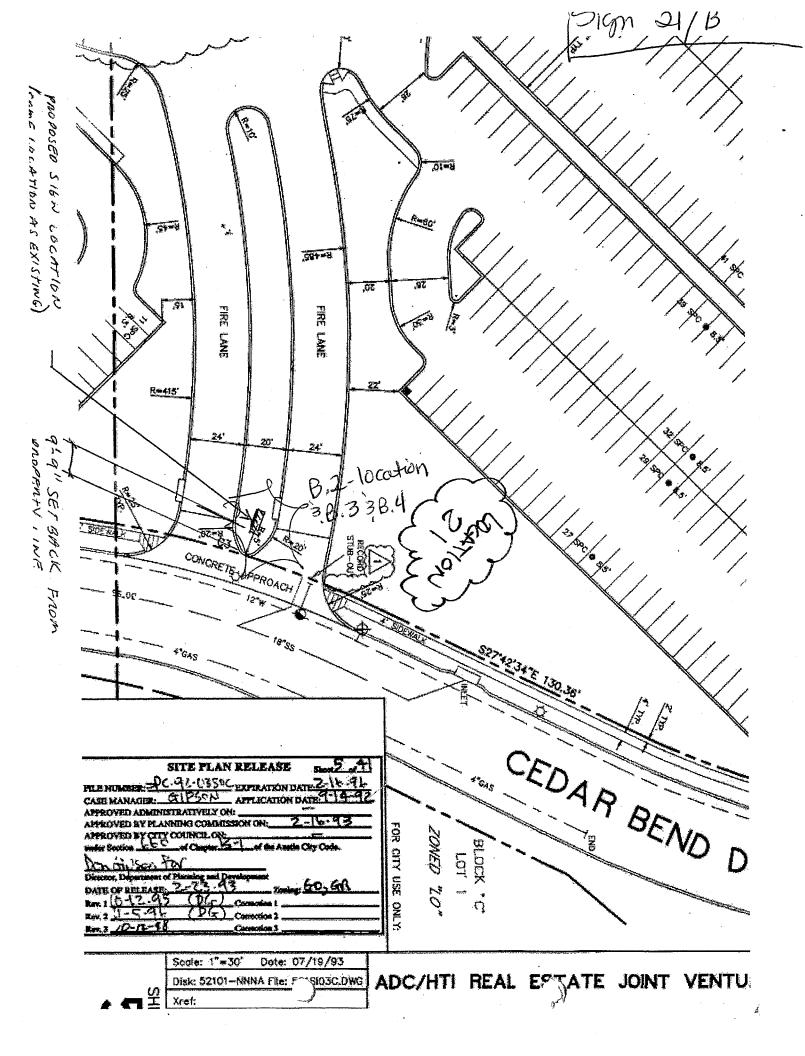

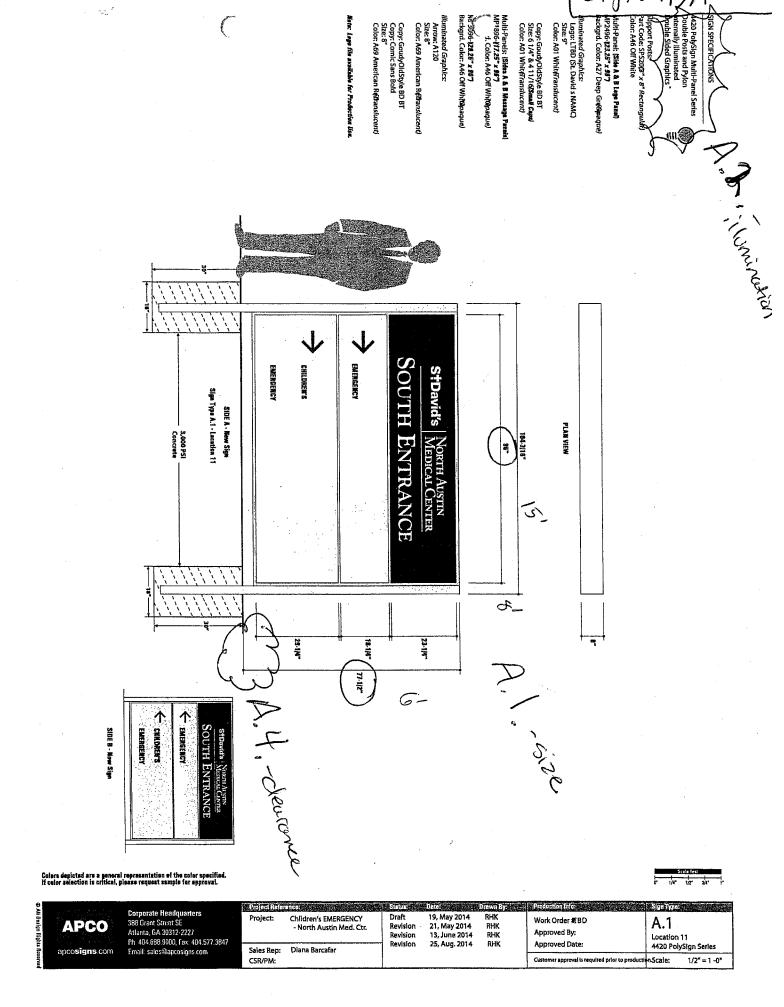

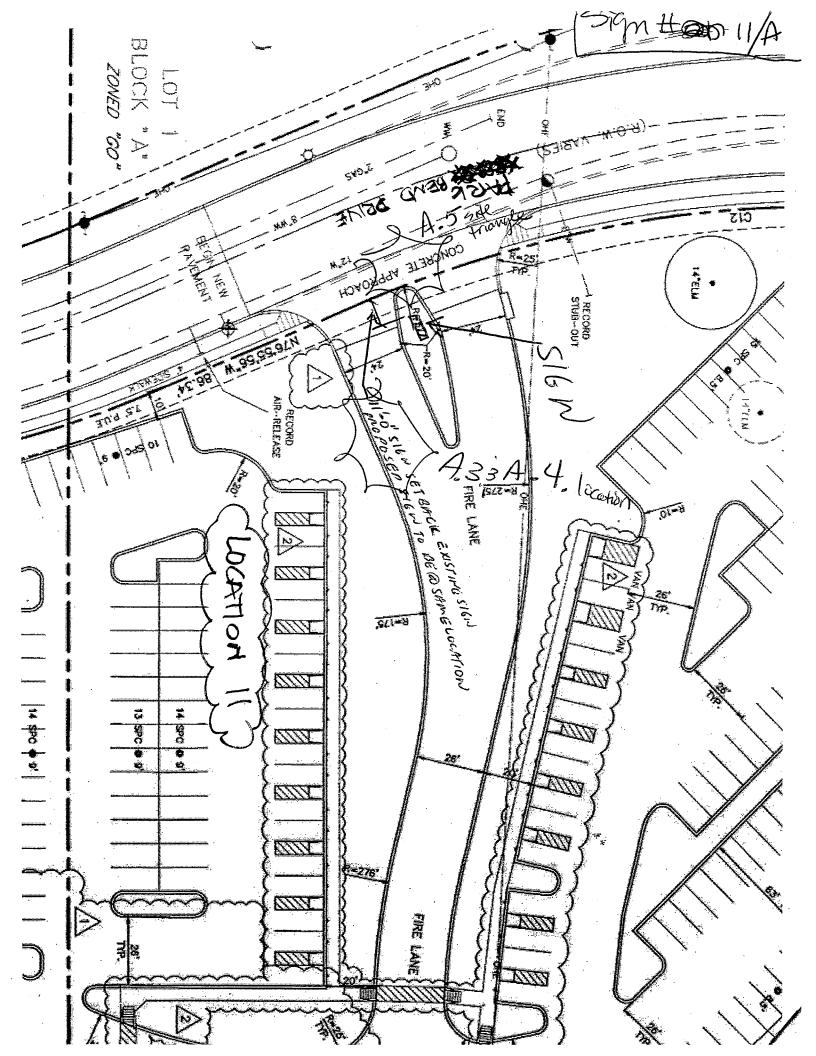

CASE#	#11	
CASE #		

# CITY OF AUSTIN APPLICATION TO SIGN REVIEW BOARD SIGN VARIANCE

WARNING: Filing of this appeal stops all affected construction activity.

PLEASE: TYPE AND COMPLETE ALL REQUESTED INFORMATION.

STREET ADDRESS: 12221 N Mo-Pac Expressway Austin, TX 78758
LEGAL DESCRIPTION: Subdivision – 36.3670 A
Lot(s) 1 Block B Outlot Centrum Division The Resub of Blk B & E
I/We_Michael A. Hunter on behalf of myself/ourselves as authorized agent for
St. David's North Austin Medical Center affirm that on October, 2014, hereby apply for a hearing before
the Sign Review Board for consideration:
ERECT - ATTACH - COMPLETE - REMODEL - MAINTAIN
Erect a new monument directional sign
in azoning district and located within the Scenic Roadway Sign District.

If your variance request is for a reduction in setbacks or height limits, please contact Eben Kellogg with the Electric Utility at (512)322-6050 and send him a scan of your request to <a href="mailto:eben.kellogg@austinenergy.com">eben.kellogg@austinenergy.com</a> before filing your application with this office to discuss your request. The Electric Utility will recommend the board deny your request if it will result in an encroachment into an electric easement or a NESC violation.

NOTE: The Board must determine the existence of, sufficiency of and weight of evidence supporting the findings described below. In order to grant your requeste for a variance, the Board must first make one or more of the findings described under 1, 2, and 3 below; the Board must then make the finding described in item 4 below. If the Board cannot make the required findings, it cannot approve a sign variance.

Therefore, you must complete each of the applicable Findings Statements as part of your application. Failure to do so may result in your application being rejected as incomplete. Please attach any additional support documents.

VARIANCE FINDINGS: I contend that my entitlement to the requested variance is based on the following findings:
1. The variance is necessary because strict enforcement of the Article prohibits any reasonable opportunity to provide adequate signs on the site, considering the unique features of a site such as its dimensions, landscaping, or topography, because: The new proposed sign is of the
same type and design as previously approved signs for this property in Phase 1
approximately 2 years ago.
OR,
2. The granting of this variance will not have a substantially adverse impact upon neighboring properties, because: We are replacing an existing sign of the same nature in the
same location.
OR,
3. The granting of this variance will not substantially conflict with the stated purposes of this sign ordinance, because: The additional size is needed to convey directions to various
medical facilities within the campus
AND,
4. Granting a variance would not provide the applicant with a special privilege not enjoyed by others similarly situated or potentially similarly situated, because: This is an emergency med-
ical facility that needs to be able to convey directional information to those in need o emergency medical care.  APPLICANT CERTIFICATE – I affirm that my statements contained in the complete application are true and correct to the best of my knowledge and belief.
Signed Meihal A Hute, Mail Address 7733 Harwell St
City, State & Zip_Fort Worth, Texas 76108
Printed Michael A Hunter Phone 817-246-4848 Date 10/30/2014
OWNERS CERTIFICATE – I affirm that my statements contained in the complete application are true and correct to the best of my knowledge and belief.
Signed Meihaul A. Hante Mail Address 7733 Harwell St
City, State & Zip_Fort Worth, Texas 76108
Printed Michael A. Hunter Phone 817-246-4848 Date 10/30/2014

ADDITIONAL INFORMATION TO BE SUBMITTED WITH COMPLETED APPLICATION: (FAILURE TO SUBMIT ALL THE REQUIRED MATERIALS WILL RESULT IN NON-ACCEPTANCE OF THE APPLICATION. BACKUP MATERIAL WILL BE ACCEPTED UNTIL 9:00 A.M. THE MONDAY PRIOR TO THE MEETING. THERE WILL BE NO **EXCEPTIONS.)** 

SITE PLAN:

Must be drawn to scale, showing present and proposed construction and locations of existing structures on adjacent lots.

All Sign Review Board cases must submit location and elevation drawings, drawn to scale, in addition to the site plan required.

APPLICATION FEES: Residential

\$388.00

All Other

\$688.00

Please be advised that the Board can only hear 16 new cases per month, therefore, applications will be accepted on a first come, first served basis.

Please be advised that a request for reconsideration of any Board action must be filed within 10 days from the Board meeting/action.

If you need assistance completing this application (general inquires only) please contact: Leane Heldenfels, (512)974-2202, leane.heldenfels@austintexas.gov or Diana Ramirez, 974-2241, Diana.ramirez@austintexas.gov 505 Barton Springs Road, 1st floor, Development Assistance Center.

NOTE: ALL VARIANCES EXPIRE 1 YEAR (12 MONTHS) FROM DATE OF APPROVAL BY BOARD AS STATED IN SECTION 25-1-217 OF THE LAND DEVELOPMENT CODE UNLESS BOARD DECISION STATES OTHERWISE.

4420 PolySign Multi-Panel Series
Double Posts and Pylon
Internally Illuminated
Double Sided Graphics\*

an 💮

Support Posts:
Part Code: SPS20(8" x 8" Rectangular)
Color: A46 Off White

Multi-Panel: **(Sids A & B Logo Panel)** MP2496-**¥23.25" x 99")** Backgrd. Color: A27 Deep Gr¢©pa*que)* 

Illuminated Graphics: Logo: LTBD (St. David s NAMC) Size: 9" Copy: GoudyOldStyle BD BT Size: 6 1/4" & 4 11/16(Small Caps) Color: A01 WhiteTranslucent) Color: A01 Whit@Translucent)

Multi-Panels: (Sides A & B Message Panels)
MP1896-(17.25" x 95")
1. Color: A46 Off Wh(tapaque)

Illuminated Graphics: Arrow: A120 Size: 8" Color: A69 American Retranslucent)

እት 3096-**(29.26" x 98")** Backgrd. Color: A46 Off Wh**የG**paque)

Color: A69 American Redranslucent) Copy: Comic Sans Bold Size: 8" Copy: GoudyOldStyle BD BT

TELENI (

Note: Lage file available for Production Usa.

PLAN VIEW

SOUTH ENTRANCE EMERGENCY EMERGENCY S†David's CHILDREN'S Sign Type A.1 - Lecation 11 SIDE A - New Sign 3,000 PSI Concrete NORTH AUSTIN MEDICAL CENTER 104-3/16" 8 29.1/4" 18-1/4" 23-1/4" 77-112" T CHILDREN'S

Colors depicted are a general representation of the color specified. If color selection is critical, please request sample for approval.

SIDE B · New Sign

**EMERGENCY** 





Corporate Headquarters 388 Grant Street SE Atlanta, GA 30312-2227 Ph: 404.688.9000, Fax: 404 Email: sales@apcosigns.com

EMERGENCY

77.3847	
n	

CSR/PM:

Project Refer	ence:
Project:	Children's EMERGENCY - North Austin Med. Ctr
Sales Rep:	Diana Barcafar

	Draft	1
	Revision	1
	Revision	•
-	Revision	:


19, May 2014 21, May 2014 13, June 2014 RHK RHK RHK 25, Aug. 2014


Work Order #TBD Approved By: Approved Date:


Customer approval is required prior to production. Scale:

**A.1** Location 11 4420 PolySign Series

1/2" = 1 -0"

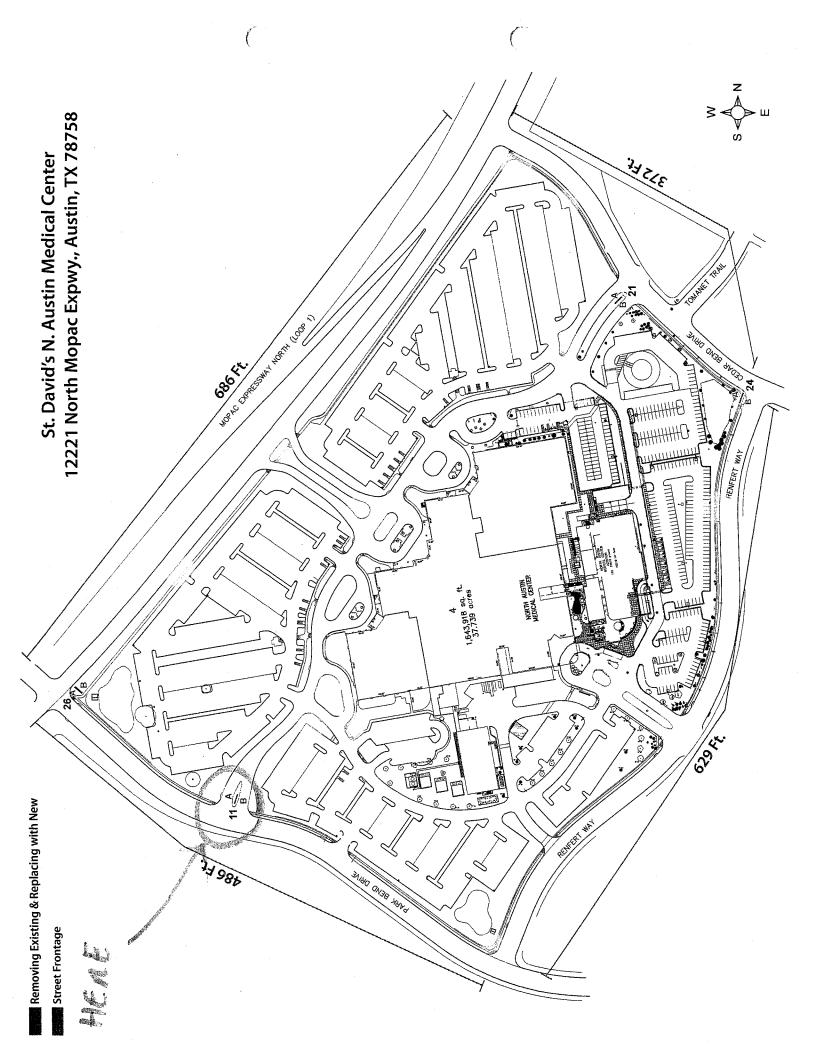

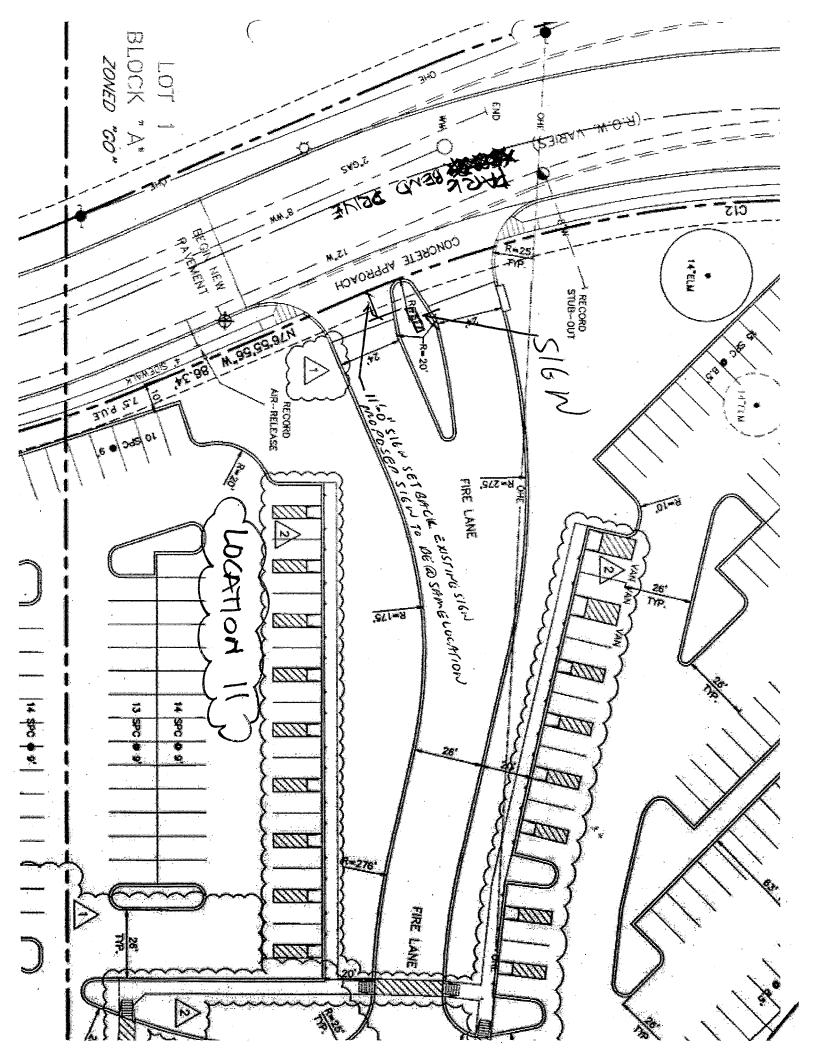

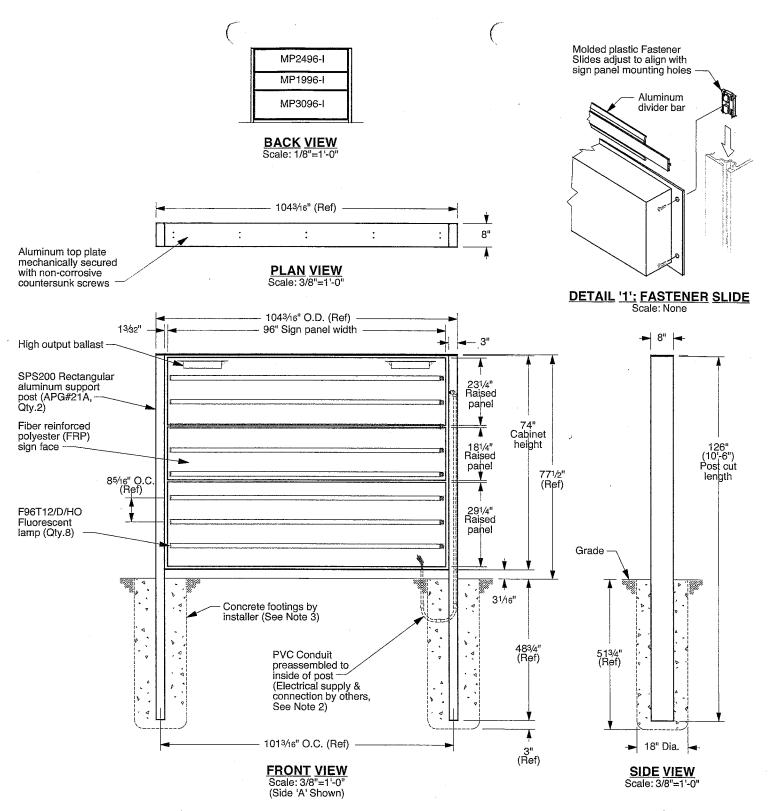

#### NOTES:

1. Refer to presentation drawing and/or work order for colors, graphics specifications and sign panel sizes.

 V Electrical supply, conduit and associated fittings are by others. Installer to increase footing size as required to route conduit. Electrical connection performed by certified persons.

Footings are shown for reference only. Actual design and installation performed by certified persons based on local codes and geographic practices.

 Lifting bolts are provided to assist with sign installation. Lifting brackets are accessible by removing post caps. Remove bolts after installation and replace post caps. Location(s)

APPROVAL BY: \_\_\_\_\_\_



Atlanta, Georgia USA • Phone: (404) 688-9000 • Web: www.apcosigns.com


All Design Rights Reserved


Customer: North Austin Medical Center
Project: Exterior Main Entrance
Location '11' - Elevation Views

Product: 4420 MultiPanel PolySign
Double Post Mount, Illuminated

Date: 10/01/14 Drawn: WWD Scale: As Shown Coord.: DTS W.O.#: 437581

Sheet: 11.a

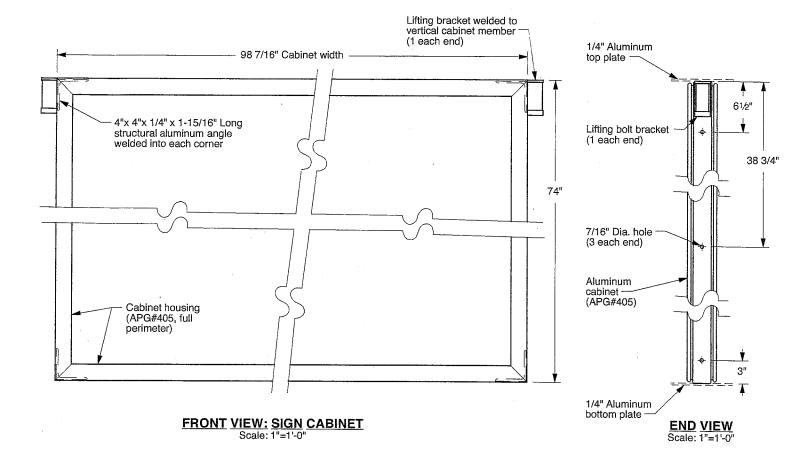

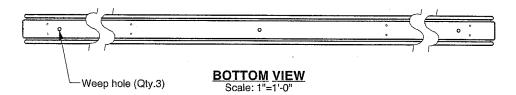

Location(s)		 	
11			

NOTES:

1. Refer to presentation drawing and/or work order for colors, graphics specifications and sign panel sizes.

APPROVAL BY: \_\_\_\_\_\_



Atlanta, Georgia USA • Phone: (404) 688-9000 • Web: www.apcosigns.com

All Design Rights Reserved


Customer: North Austin Medical Center Project: Exterior Main Entrance

Location '11' - Cabinet Details
Product: 4420 MultiPanel PolySign
Double Post Mount, Illuminated


Drawn: WWD Scale: As Shown Coord.: DTS W.O.#: 437581


Date: 10/01/14

Sheet: 11.b

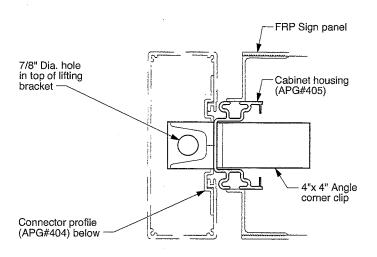


# SECTION: "11.c1" Scale: 1/4"=1"

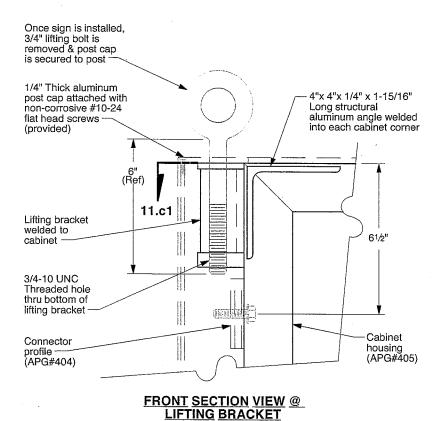


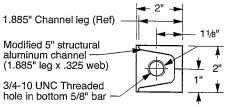

Scale: 1/4"=1"

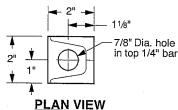

**PLAN VIEW** Scale: 1/4"=1

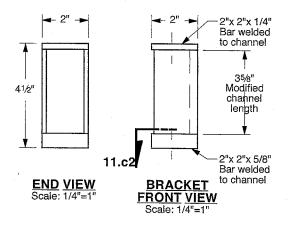

# Scale: 1/4"=1

NOTES:

1. Lifting bolts are provided to assist with sign installation. Lifting brackets are accessible by removing post caps. In order to maintain structural integrity of the cabinet, use spreader beam and maintain a 90° angle between cabinet and both lifting bolts. Remove bolts after installation and replace post caps.

Location(s) 11

APPROVAL BY: -REQUIRED DATE: \_



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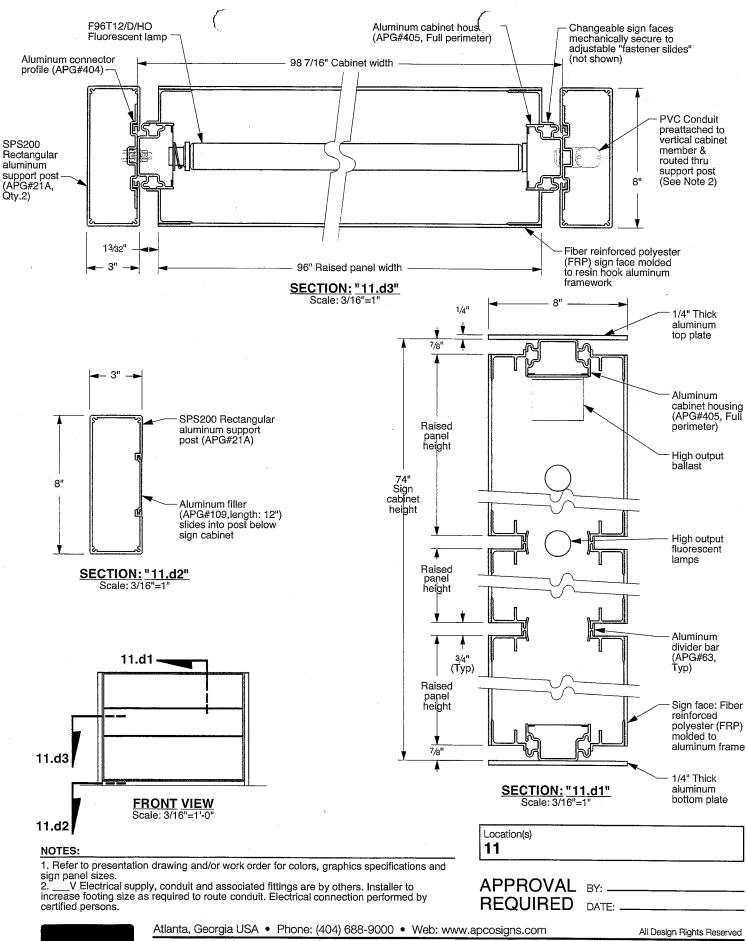
Customer: North Austin Medical Center

Project: Exterior Main Entrance
Location '11' - Lifting Bracket Details
Product: 4420 MultiPanel PolySign

Double Post Mount, Illuminated

Date: 10/01/14 Drawn: WWD Scale: As Shown Coord.: DTS W.O.#: 437581

Sheet: 11.c







apcosigns.com


Customer: North Austin Medical Center Project: Exterior Main Entrance Location '11' - Section Views Product: 4420 MultiPanel PolySign
Double Post Mount, Illuminated

Date: 10/01/14 Drawn: WWD Scale: As Shown Coord.: DTS W.O.#: 437581

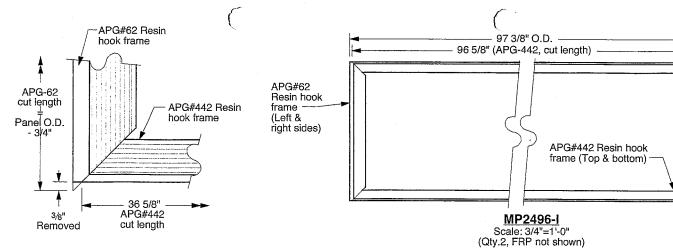

TYPICAL CORNER DETAIL Scale: 1/4"=1'

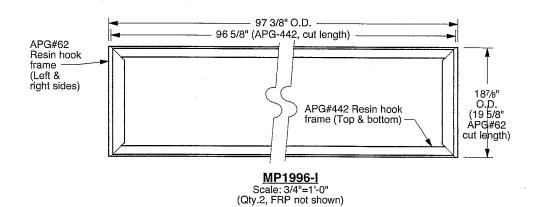

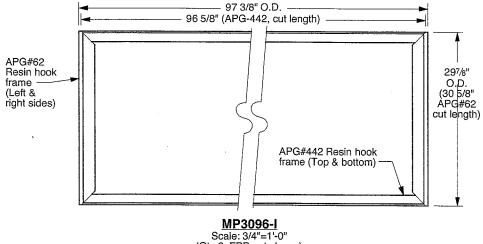

Scale: 3/4"=1'-0" (Qty.2, FRP not shown)

Location(s) 11
----------------

NOTES:

1. Refer to presentation drawing and/or work order for colors, graphics specifications and sign panel sizes.

APPROVAL BY: -REQUIRED DATE: \_

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Customer: North Austin Medical Center Project: Exterior Main Entrance

Location '11' - Section Views Product: 4420 MultiPanel PolySign

Double Post Mount, Illuminated

Scale: As Shown Coord.: DTS W.O.#: 437581

Drawn: WWD

Date: 10/01/14


Sheet: 11.e

237/8' O.D.

(24 5/8"

ÀPG#62

cut length)

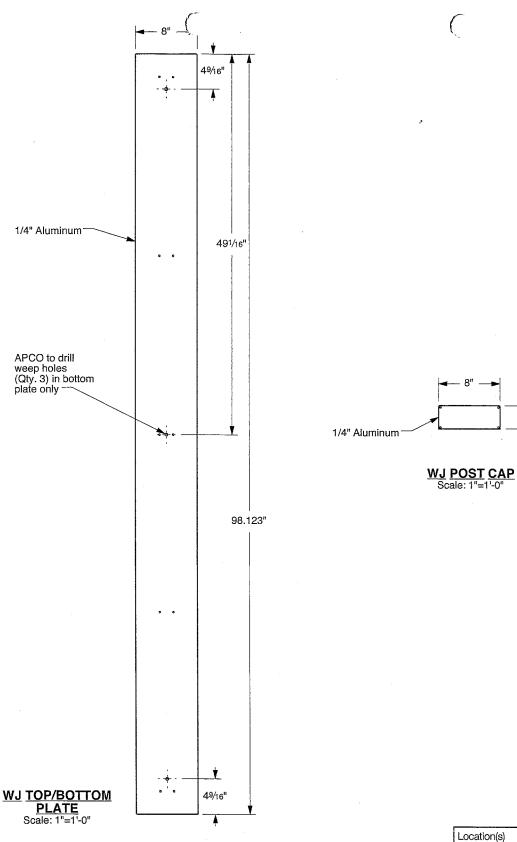

Location(s)	 	
11		
• •		

NOTES:

1. Refer to presentation drawing and/or work order for colors, graphics specifications and sign panel sizes.

APPROVAL BY: \_\_\_\_\_\_



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Customer: North Austin Medical Center Project: Exterior Main Entrance


Location '11' - Water-Jet Parts
Product: 4420 MultiPanel PolySign
Double Post Mount, Illuminated

Date: 10/01/14 Drawn: WWD Scale: As Shown Coord.: DTS W.O.#: 437581

3"

Sheet: 11.f

		(
Revisions	Date	Check
Wall increased from .125" to	12/16/03	RCB
.140". Tolerance added &		
screwways changed from 90°		
to 60°		
Redrawn in Graphite	12/06/06	WWD

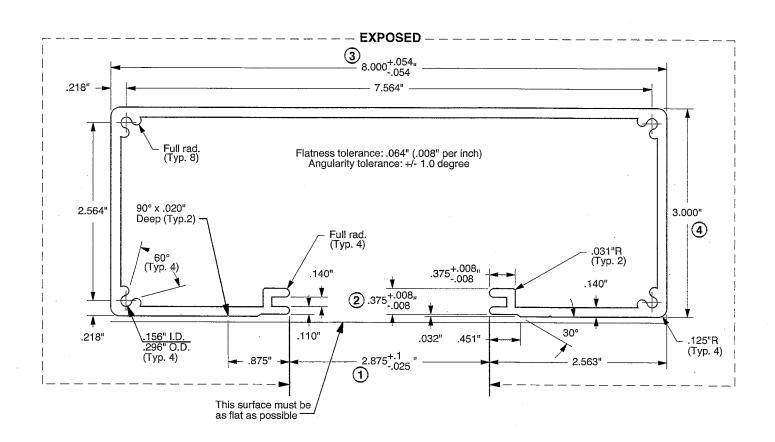

#### APG#21A


Wt. Per Area 1.2 Perimeter 40.242 2.753 3.303 Area Weight Centroid X Centroid Y Inertia IXX Inertia IYY -0 .769 4.422 25.196 Inertia IXY .001

Notes:
1. All design rights reserved.
2. All dimensions are in inches unless otherwise noted.
3. Numbered Bullets are Primary Inspected Areas.


### **APCO**

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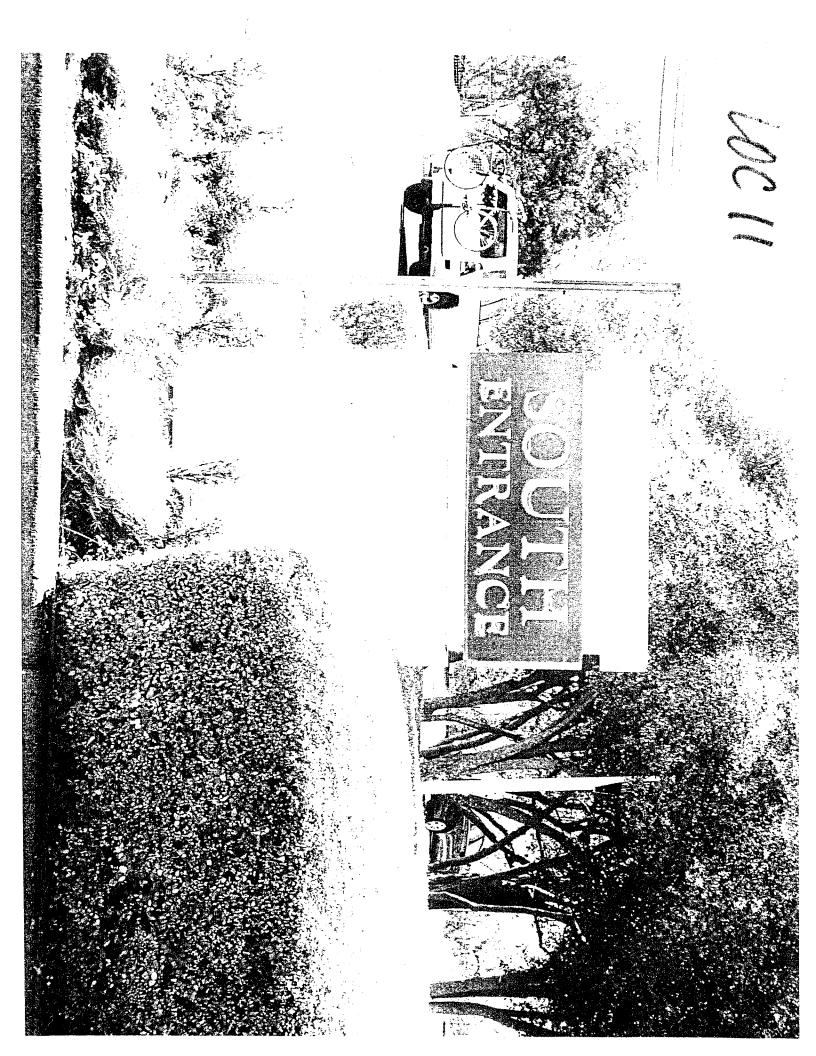
	m Assoc. Std nless Shown (			Solid ( ) Semi-Hollow ( )		Unspecified 0.010"R Corners 0.25 mm		' = 1"	<sub>Date</sub> 12/09/03				
Est. Area	2.753	Est. Weight	3.303 <sub>lbs./ft.</sub> 4.919 <sub>kg/m</sub>	Hollow I Hollow II	{x}	Alloy 6063	3-T5	Finish	Mill	Die Ad Status	ctive	Order S Code	PS200
Est. Perimeter	40.242" <sub>Ext.</sub>	USA Stock Length	24'-1"	Drawn	JMM	Description	Pos	t 3"	x 8" Rect	angular		APC	3- 21A



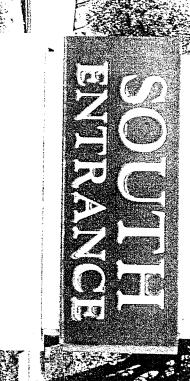



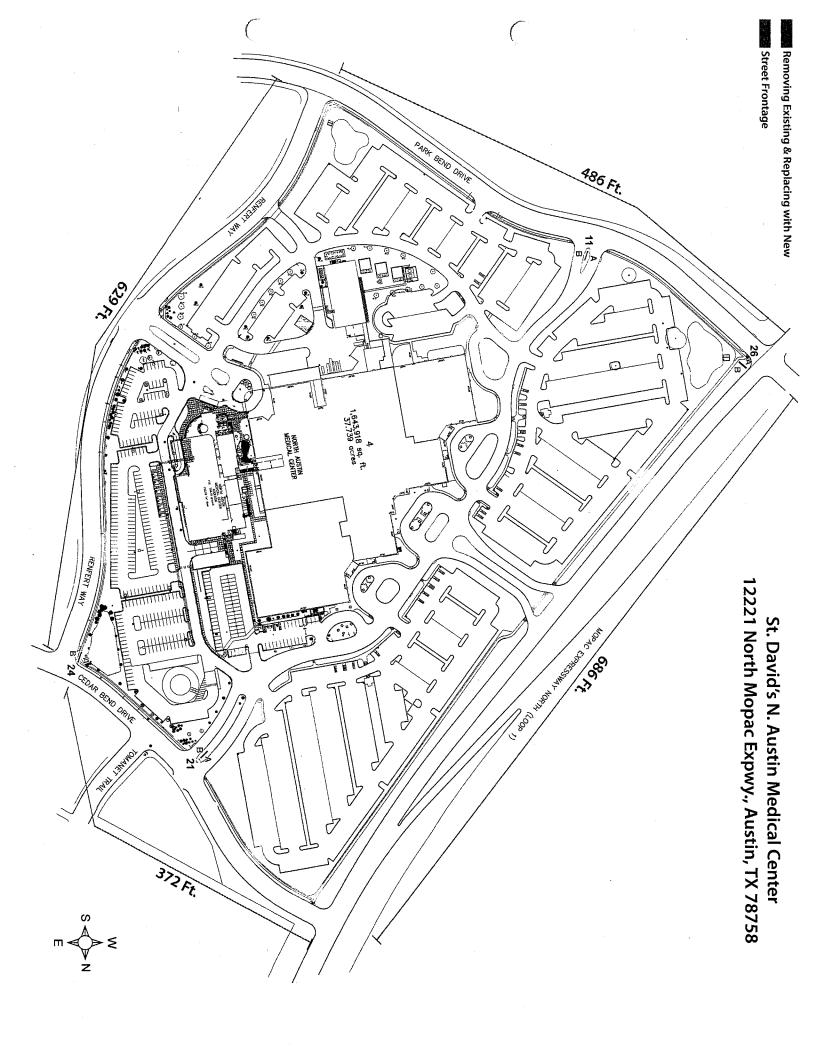



	$\mathcal{K}\mathcal{M}$	
CASE #_	(X) U \	

# CITY OF AUSTIN APPLICATION TO SIGN REVIEW BOARD SIGN VARIANCE

WARNING: Filing of this appeal stops all affected construction activity.

PLEASE: TYPE AND COMPLETE ALL REQUESTED INFORMATION.

STREET ADDRESS: 12221 N Mo-Pac Expressway Austin, TX 78758
LEGAL DESCRIPTION: Subdivision – 36.3670 A
Lot(s) 1 Block B Outlot Centrum Division The Resub of Blk B & E
I/We Michael A. Hunter on behalf of myself/ourselves as authorized agent for
St. David's North Austin Medical Center affirm that on October , 2014, hereby apply for a hearing before
the Sign Review Board for consideration:
ERECT – ATTACH – COMPLETE – REMODEL – MAINTAIN
Erect a new monument directional sign
in azoning district and located within the Scenic Roadway Sign District.

If your variance request is for a reduction in setbacks or height limits, please contact Eben Kellogg with the Electric Utility at (512)322-6050 and send him a scan of your request to <a href="mailto:eben.kellogg@austinenergy.com">eben.kellogg@austinenergy.com</a> before filing your application with this office to discuss your request. The Electric Utility will recommend the board deny your request if it will result in an encroachment into an electric easement or a NESC violation.

NOTE: The Board must determine the existence of, sufficiency of and weight of evidence supporting the findings described below. In order to grant your requeste for a variance, the Board must first make one or more of the findings described under 1, 2, and 3 below; the Board must then make the finding described in item 4 below. If the Board cannot make the required findings, it cannot approve a sign variance.

Therefore, you must complete each of the applicable Findings Statements as part of your application. Failure to do so may result in your application being rejected as incomplete. Please attach any additional support documents.

VARIANCE FINDINGS: I contend that my entitlement to the requested variance is based on the following findings:
1. The variance is necessary because strict enforcement of the Article prohibits any reasonable opportunity to provide adequate signs on the site, considering the unique features of a site such as its dimensions, landscaping, or topography, because: The new proposed sign is of the
same type and design as previously approved signs for this property in Phase 1
approximately 2 years ago.
OR,
2. The granting of this variance will not have a substantially adverse impact upon neighboring properties, because: We are replacing an existing sign of the same nature in the
same location
OR,
3. The granting of this variance will not substantially conflict with the stated purposes of this sign ordinance, because: The additional size is needed to convey directions to various
medical facilities within the campus
AND,
4. Granting a variance would not provide the applicant with a special privilege not enjoyed by others similarly situated or potentially similarly situated, because: This is an emergency med-
ical facility that needs to be able to convey directional information to those in need of emergency medical care.  APPLICANT CERTIFICATE – I affirm that my statements contained in the complete application are true and correct to the best of my knowledge and belief.
Signed Meihal A Harte Mail Address 7733 Harwell St
City, State & Zip Fort Worth, Texas 76108
Printed Michael A Hunter Phone 817-246-4848 Date 10/30/2014
OWNERS CERTIFICATE – I affirm that my statements contained in the complete application are true and correct to the best of my knowledge and belief.
Signed // Wichard / Hanter Mail Address 7733 Harwell St
City, State & Zip_Fort Worth, Texas 76108
Printed Michael A. Hunter Phone 817-246-4848 Date 10/30/2014

ADDITIONAL INFORMATION TO BE SUBMITTED WITH COMPLETED APPLICATION: (FAILURE TO SUBMIT ALL THE REQUIRED MATERIALS WILL RESULT IN NON-ACCEPTANCE OF THE APPLICATION. BACKUP MATERIAL WILL BE ACCEPTED UNTIL 9:00 A.M. THE MONDAY PRIOR TO THE MEETING. THERE WILL BE NO EXCEPTIONS.)

SITE PLAN:

Must be drawn to scale, showing present and proposed construction and locations of existing structures on adjacent lots.

All Sign Review Board cases must submit location and elevation drawings, drawn to scale, in addition to the site plan required.

APPLICATION FEES: Residential

\$388.00

All Other

\$688.00

Please be advised that the Board can only hear 16 new cases per month, therefore, applications will be accepted on a first come, first served basis.

Please be advised that a request for reconsideration of any Board action must be filed within 10 days from the Board meeting/action.

If you need assistance completing this application (general inquires only) please contact: Leane Heldenfels, (512)974-2202, <a href="mailto:leane.heldenfels@austintexas.gov">leane.heldenfels@austintexas.gov</a> or Diana Ramirez, 974-2241, <a href="mailto:Diana.ramirez@austintexas.gov">Diana.ramirez@austintexas.gov</a> 505 Barton Springs Road, 1<sup>st</sup> floor, Development Assistance Center.

NOTE: ALL VARIANCES EXPIRE 1 YEAR (12 MONTHS) FROM DATE OF APPROVAL BY BOARD AS STATED IN SECTION 25-1-217 OF THE LAND DEVELOPMENT CODE UNLESS BOARD DECISION STATES OTHERWISE.

4420 PolySign Multi-Panel Series
Double Posts and Pylon
Internally Illuminated
Double Sided Graphics\*

411

Support Posts: Part Code: SPS20(3" x 8" Rectangular) Color: A46 Off White

fluminated Graphics: Logo: LTBD (St. David s NAMC) Size: 9" Color: A01 WhiteTranslucent)

Copy: GoudyOldStyle BD BT Size: 6 1/4" & 4 11/16**/Small Caps)** Color: A01 Whit*eTranslucent*)

MP1272-**(11.25" x 72")** d. Color: A46 Off Wh**(G**paque)

Illuminated Graphics: Arrow: A120

Copy: GoudyOldStyle BD BT

Color: DayLit*éTranslucent)* Color: A69 American R**étr**anslucent)

Backgrd. Color: A46 Off Whttapaque)

MP3672-(35.25" x 72") Backgrd. Color: A46 Off Whitapaque)

Illuminated Graphics:

Color: A69 American Rethanslucent)

py: Comic Sans Bold

Note: Lego file available for Production Uxe.

Draft Revision Revision

RHK

RHK RHK Work Order #BD Approved By:

**A.1** 

Multi-Panel: (Side A & B Logo Panel) MP2472-(23,25" x 72") Backgrd. Color: A27 Deep Gr¢⊖paque)

iulti-Panels: (Side A Message Panels)

ฟ้าวี672-**(35.25" x 72")** Backgrd. Color: A46 Off Wh**it**@paque)

Color: DayLite*Translucent)* Color: A69 American Retranslucent)

Multi-Panels: (Side 8 Message Panels)

Arrow: A120 olor: DayLit*{Translucent)* 

ρy: GoudyOldStyle BD BT

Color: DayLit@ranslucent)
Color: A69 American R@ranslucent)

NORTH ENTRANCE **→ EMERGENCY** StDavid's North Austin Medical Center CHILDREN'S EMERGENCY Sign Type A.1 - Location 21 SIDE A - New Sign PLAN VIEW 3,000 PSI Concrete 80-3/16" 72" 35-1/4" 11-114" 23-1/4"

81" (Nem.)


SIDE B - New Sign


个 CHILDREN'S EMERGENCY


**← EMERGENCY** 


ORTH ENTRANC

Colors depicted are a general representation of the color specified. If color selection is critical, please request sample for approval.

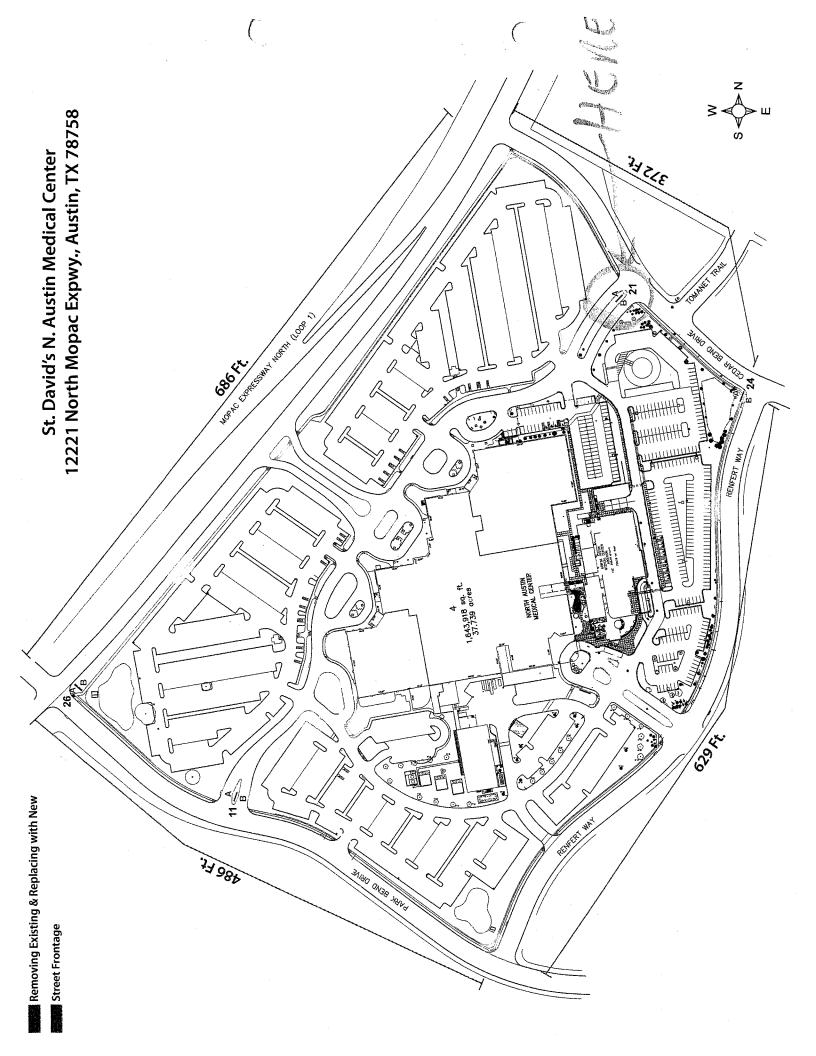


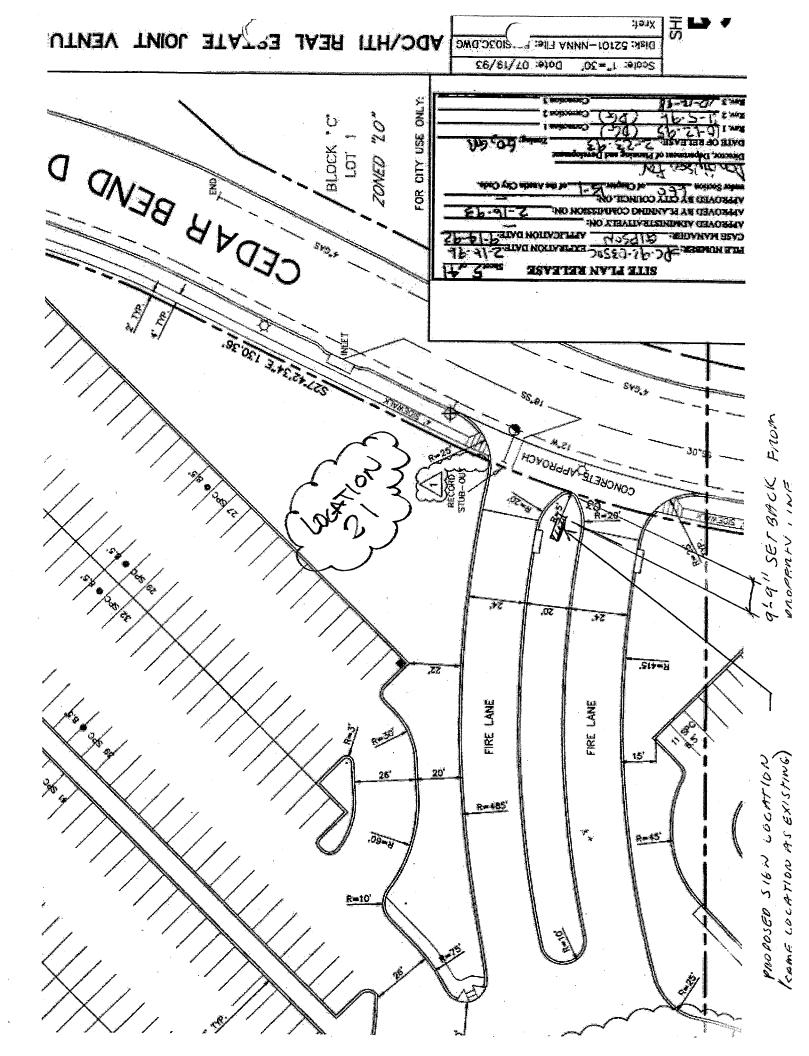

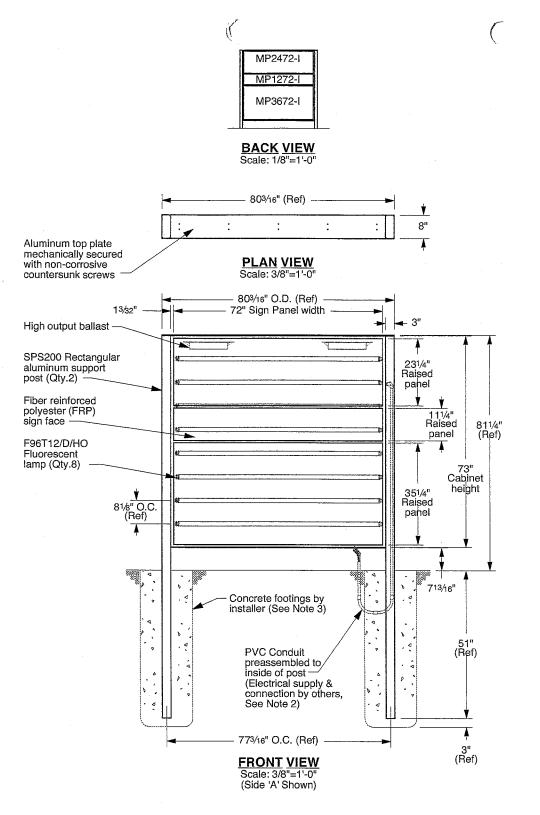

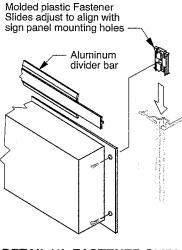

**DETAIL '1': FASTENER SLIDE** 

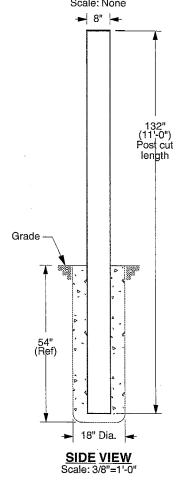

#### NOTES:

1. Refer to presentation drawing and/or work order for colors, graphics specifications and sign panel sizes.

 V Electrical supply, conduit and associated fittings are by others. Installer to increase footing size as required to route conduit. Electrical connection performed by certified persons.

3. Footings are shown for reference only. Actual design and installation performed by

certified persons based on local codes and geographic practices.

4. Lifting bolts are provided to assist with sign installation. Lifting brackets are accessible by removing post caps. Remove bolts after installation and replace post caps.

Location(s) 21

APPROVAL BY: \_ REQUIRED DATE: \_



apcosigns.com


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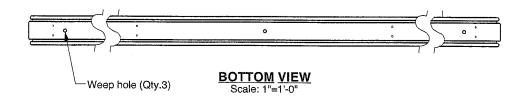
Customer: North Austin Medical Center Project: Exterior Main Entrance Location '21' - Elevation Views Product: 4420 MultiPanel PolySign Double Post Mount, Illuminated

Date: 10/01/14 Drawn: WWD Scale: As Shown Coord.: DTS W.O.#: 437581

Lifting bracket welded to vertical cabinet member (1 each end) 74 7/16" Cabinet width -4"x 4"x 1/4" x 1-15/16" Long structural aluminum angle welded into each corner 73" Cabinet housing (APG#405, full perimeter)



FRONT VIEW: SIGN CABINET
Scale: 1"=1'-0"

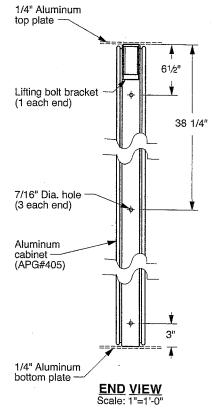

Location(s)	
21	

NOTES:

1. Refer to presentation drawing and/or work order for colors, graphics specifications and sign panel sizes.

APPROVAL BY: \_\_\_\_ REQUIRED DATE: \_



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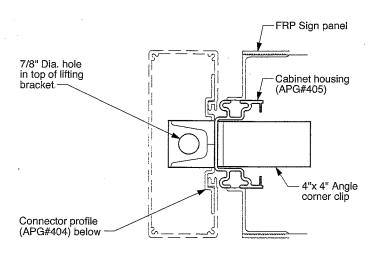
All Design Rights Reserved

Customer: North Austin Medical Center


Project: Exterior Main Entrance Location '21' - Cabinet Details Product: 4420 MultiPanel PolySign Double Post Mount, Illuminated


Date: 10/01/14 Drawn: WWD Scale: As Shown Coord.: DTS W.O.#: 437581

Sheet: 21.b



# Section: "21.c1" Scale: 1/4"=1"

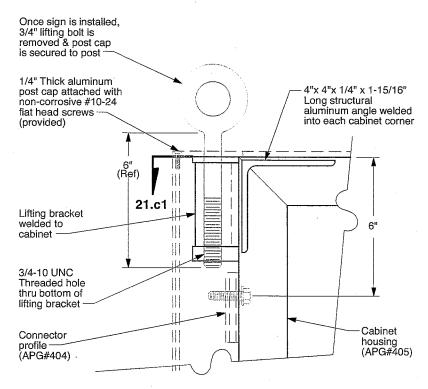

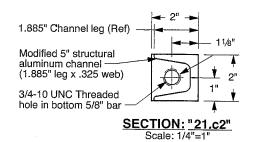

7/8" Dia. hole in top 1/4" bar 2" PLAN VIEW Scale: 1/4"=1

2"x 2"x 1/4" Bar welded to channel 35/8" Modified 41/2" channel length 21.c2 2"x 2"x 5/8" Bar welded to channel **END VIEW BRACKET** Scale: 1/4"=1" **FRONT VIEW** Scale: 1/4"=1"

FRONT SECTION VIEW @ LIFTING BRACKET Scale: 1/4"=1

NOTES:

1. Lifting bolts are provided to assist with sign installation. Lifting brackets are accessible by removing post caps. In order to maintain structural integrity of the cabinet, use spreader beam and maintain a 90° angle between cabinet and both lifting bolts. Remove bolts after installation and replace post caps.

Location(s) 21

APPROVAL BY: -REQUIRED DATE: \_



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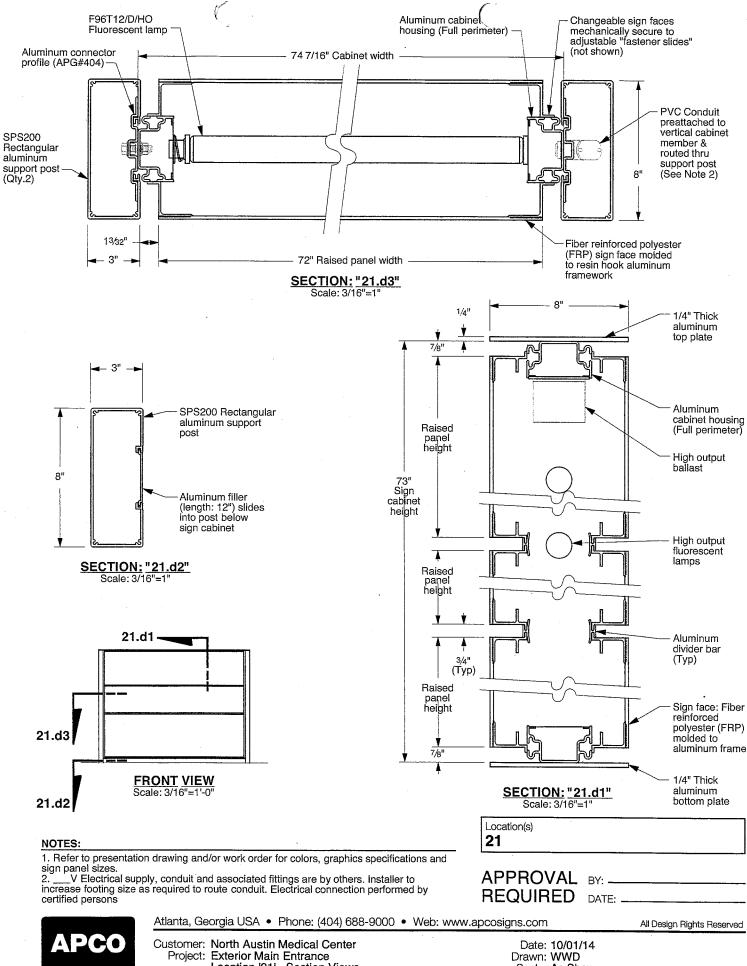
Customer: North Austin Medical Center Project: Exterior Main Entrance

Location '21' - Lifting Bracket Details
Product: 4420 MultiPanel PolySign

Double Post Mount, Illuminated

Date: 10/01/14 Drawn: WWD Scale: As Shown Coord.: DTS W.O.#: 437581

Sheet: 21.c





apcosigns.com

Location '21' - Section Views Product: 4420 MultiPanel PolySign Double Post Mount, Illuminated

Scale: As Shown Coord.: DTS W.O.#: 437581

Sheet: 21.d

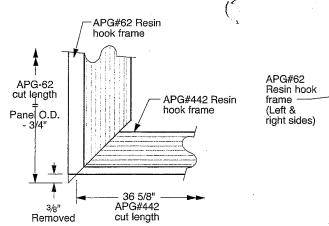

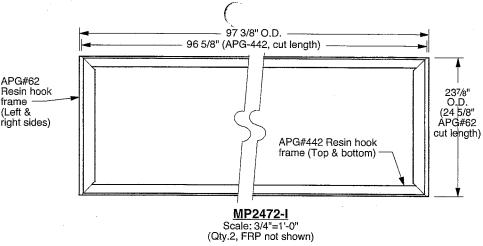


TYPICAL CORNER DETAIL
Scale: 1/4"=1"

97 3/8" O.D.

96 5/8" (APG-442, cut length)

117/8"
O.D.
(12 5/8"
APG#442 Resin hook
frame (Top & bottom)

MP1272-I
Scale: 3/4"=1'-0"
(Qty.2, FRP not shown)

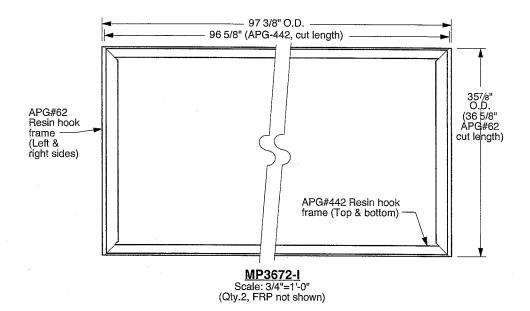

Location(s)
21

NOTES:

1. Refer to presentation drawing and/or work order for colors, graphics specifications and sign panel sizes.

APPROVAL BY: \_\_\_\_\_\_



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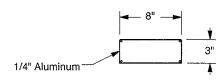
Customer: North Austin Medical Center
Project: Exterior Main Entrance
Location '21' - Section Views
Product: 4420 MultiPanel PolySign

Double Post Mount, Illuminated


Drawn: WWD Scale: As Shown Coord.: DTS W.O.#: 437581

Date: 10/01/14

Sheet: 21.e



#### WJ POST CAP Scale: 1"=1'-0"

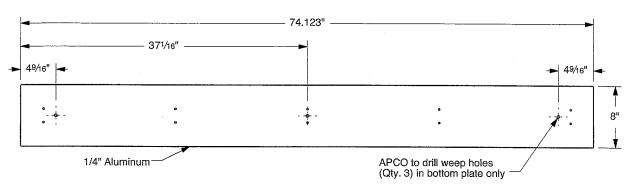

WJ TOP/BOTTOM PLATE

Location(s)		-	
21			

NOTES:

1. Refer to presentation drawing and/or work order for colors, graphics specifications and sign panel sizes.

APPROVAL BY: \_\_\_\_\_



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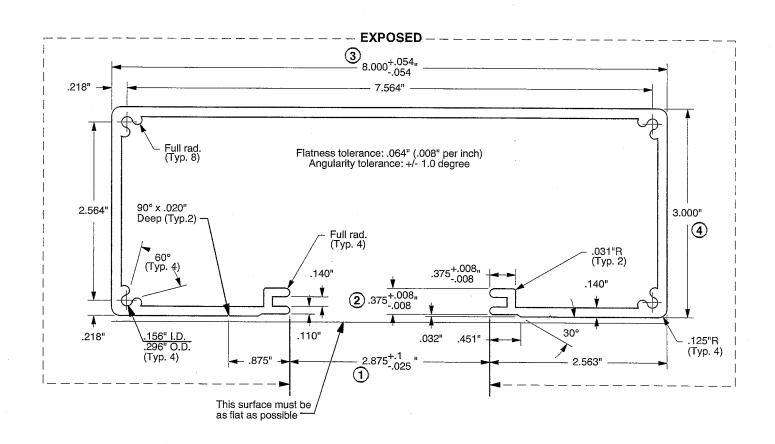
Customer: North Austin Medical Center Project: Exterior Main Entrance

Location '21' - Water-Jet Parts
Product: 4420 MultiPanel PolySign
Double Post Mount, Illuminated

Date: 10/01/14 Drawn: WWD Scale: As Shown Coord.: DTS W.O.#: 437581

Sheet: 21.f

		1
Revisions	Date	Check
Wall increased from .125" to	12/16/03	RCB
.140". Tolerance added &		
screwways changed from 90°		
to 60°	1	
Redrawn in Graphite	12/06/06	M/M/D



#### APG#21A

Wt. Per Area Perimeter	1.2 40.242
Area	2.753
Weight	3.303
Centroid X	-0
Centroid Y Inertia IXX	.769 4.422
Inertia IYY	25.196
Inertia IXY	.001

#### Notes:

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 All dimensions are in inches unless otherwise noted.
 Numbered Bullets are Primary Inspected Areas.

## **APCO**

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Aluminum Assoc. Std. Tolerances Apply Unless Shown Otherwise				Solid ( ) Semi-Hollow ( )		Unspecified 0.010"R Corners 0.25 mm		Typ. Wall Unless Noted			" = 1" Date 12/09/03		9/03	
Est. Area	2.753	Est. Weight	3.303 <sub>lbs./ft.</sub> 4.919 <sub>kg/m</sub>	Hollow I Hollow II	{ x }	Alloy 6063-	T5	Finish	Mill	Die Ad Status	tive	Order S	PS200	
Est. Perimeter	40.242" <sub>Ext.</sub>	USA Stock Length	24'-1"	Drawn	JMM	Description F	Post	3" :	x 8" Recta	angular		APC	3- 21A	

# ONGENERAGI



# CITY OF AUSTIN APPLICATION TO SIGN REVIEW BOARD SIGN VARIANCE

WARNING: Filing of this appeal stops all affected construction activity.

PLEASE: TYPE AND COMPLETE ALL REQUESTED INFORMATION.

STREET ADDRESS: 12221 N Mo-Pac Expressway Austin, TX 78758

LEGAL DESCRIPTION: Subdivision – 36.3670 A

Lot(s) 1 Block B Outlot Centrum Division The Resub of Blk B & E

I/We Michael A. Hunter on behalf of myself/ourselves as authorized agent for

St. David's North Austin Medical Center affirm that on October , 2014, hereby apply for a hearing before

the Sign Review Board for consideration:

ERECT - ATTACH - COMPLETE - REMODEL - MAINTAIN

Erect a new monument directional sign


in a	zoning district and	located within the	Scenic Roadway
Sign District.			


If your variance request is for a reduction in setbacks or height limits, please contact Eben Kellogg with the Electric Utility at (512)322-6050 and send him a scan of your request to <a href="mailto:eben.kellogg@austinenergy.com">eben.kellogg@austinenergy.com</a> before filing your application with this office to discuss your request. The Electric Utility will recommend the board deny your request if it will result in an encroachment into an electric easement or a NESC violation.

NOTE: The Board must determine the existence of, sufficiency of and weight of evidence supporting the findings described below. In order to grant your requeste for a variance, the Board must first make one or more of the findings described under 1, 2, and 3 below; the Board must then make the finding described in item 4 below. If the Board cannot make the required findings, it cannot approve a sign variance.

Therefore, you must complete each of the applicable Findings Statements as part of your application. Failure to do so may result in your application being rejected as incomplete. Please attach any additional support documents.

VARIANCE FINDINGS: I contend that my entitlement to the requested variance is based on the following findings:
1. The variance is necessary because strict enforcement of the Article prohibits any reasonable opportunity to provide adequate signs on the site, considering the unique features of a site such as its dimensions, landscaping, or topography, because: The new proposed sign is of the
same type and design as previously approved signs for this property in Phase 1
approximately 2 years ago.
OR,
2. The granting of this variance will not have a substantially adverse impact upon neighboring properties, because: We are replacing an existing sign of the same nature in the
same location.
OR,
3. The granting of this variance will not substantially conflict with the stated purposes of this sign ordinance, because: The additional size is needed to convey directions to various
medical facilities within the campus
AND,
4. Granting a variance would not provide the applicant with a special privilege not enjoyed by others similarly situated or potentially similarly situated, because: This is an emergency med-
ical facility that needs to be able to convey directional information to those in need of emergency medical care.  APPLICANT CERTIFICATE – I affirm that my statements contained in the complete application are true and correct to the best of my knowledge and belief.
Signed // What / Hate Mail Address 7733 Harwell St
City, State & Zip_Fort Worth, Texas 76108
Printed Michael A Hunter Phone 817-246-4848 Date 10/30/2014
OWNERS CERTIFICATE – I affirm that my statements contained in the complete application are true and correct to the best of my knowledge and belief.
Signed Meichaul H. Flank Mail Address 7733 Harwell St
City, State & Zip Fort Worth, Texas 76108
Printed Michael A. Hunter Phone 817-246-4848 Date 10/30/2014

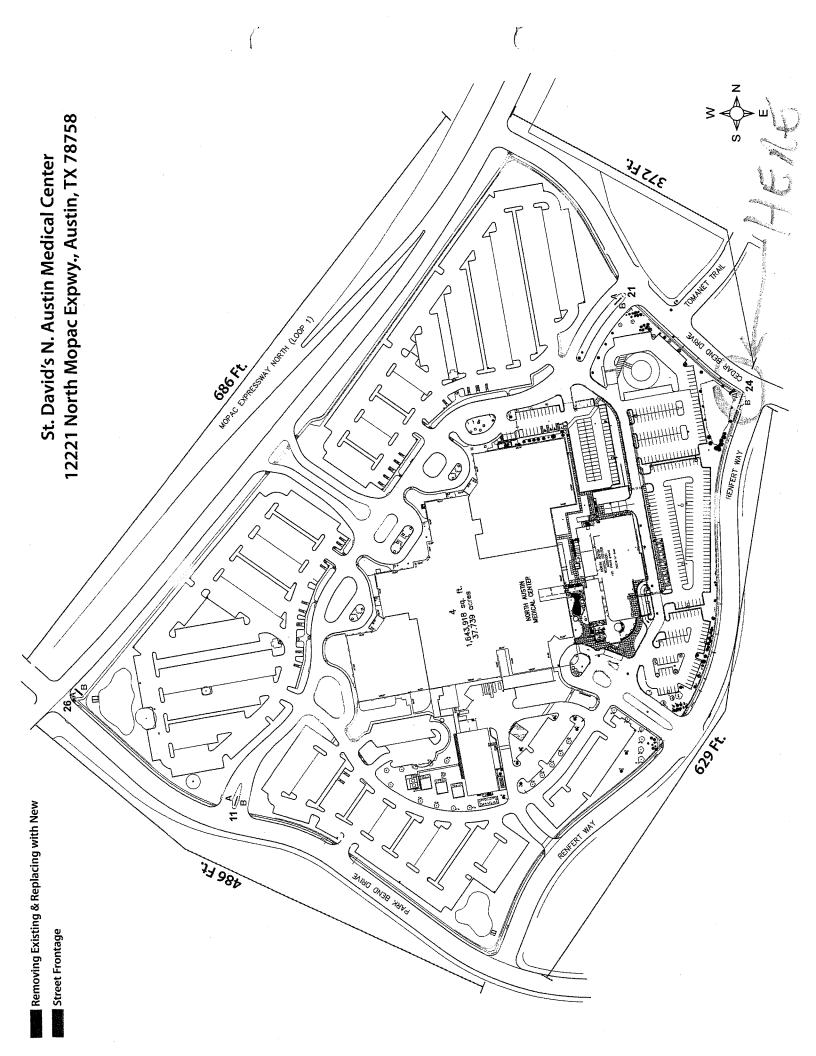

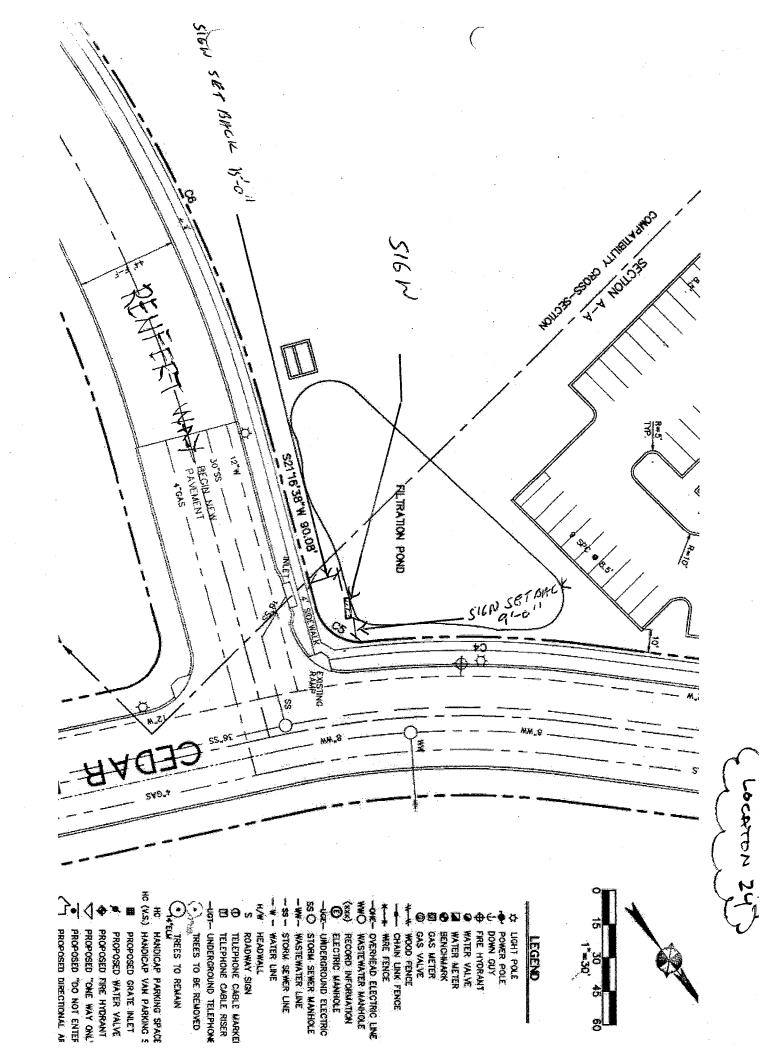

PLAN VIEW

Double Sided Graphics®

4420 PolySign Multi-Panel Series Double Posts and Pylon Internally Illuminated

Support Posts:
Part Code: SPS20(B" x 8" Rectangular)
Color: A46 Off White

Backgrd. Color: A27 Deep Gr**∉©**paque) Multi-Panel: (Side A & B Lego Panel) MP2472-123.25" x 72")

Copy: GoudyOldStyle BD BT Size: 6 1/4" & 4 11/16/Small Caps) Color: A01 WhiteTranslucent) Logo: LTBD (St. David s NAMC) Size: 9" Color: A01 WhiteTranslucent)

Illuminated Graphics:

Multi-Panels: (Side A Message Panels) MP4872-(47.25" x 72") yrd. Color: A46 Off Whitepaque)

Backgrd. Color: A46 Off Wh**řía**paque) Illuminated Graphics: ~5072(49.25" x 72") (Blank)

Arrow: A120 Size: 6" Copy: GoudyOldStyle BD BT Color: DayLit*@ranslucent)* Color: A69 American R**¢B**ranslucent)

Multi-Panels: (Side B Message Panels)
MP1272-(11.25" x 72") Color: DayLitéTranslucent) Color: A69 American Rétranslucent)

MP2072**-{19.25" x 72")** Backgrd. Color: A46 Off Whi**'@**paque) 3ackgrd. Color: A46 Off Whita*paque)* 

Backgrd. Color: A46 Off Whitapaque) MP1272-**(11.25" x 72")** 

MP5272**/51.25" x 72") (Blank)** Backgrd. Color: A46 Off Whit@paque)

Color: DayLit@Translucent)
Color: A69 American R@Translucent) ated Graphics: ow: A120

Copy: Comic Sans Bold Size: 5" Copy: GoudyOldStyle BD BT

Color: DayLit@ranslucent)
Color: A69 American R@ranslucent)

Sign Type B · Location 24 SIDE A . New Sign

3,000 PSI

Note: Lego file available for Production Use

S†David's | NORTH AUSTIN | MEDICAL CENTER EAST ENTRANCE \* East & South Entrances Women's Center 72" 47-1/4" 23-1/4"

← East, South & T EMERGENCY ↑ North Entrance EAST ENTRANCE T CHILDREN'S EMERGENCY West Entrances Women's Center

Colors depicted are a general representation of the color specified. If color selection is critical, please request sample for approval.



APCO

SIDE B - New Sign

Corporate Headquarters 388 Grant Street SE Atlanta, GA 30312-2227 Ph: 404.688.9000, Fax: 404.577.38-Email: sales@apcosigns.com


	Project Refe	01
	Project:	
7	Sales Rep:	_
	eco (n)	


47.1/4"

oject Refe	ance:	Status:	Date:	ni.
oject:	Children's EMERGENCY	Draft	19, May 2014	F
	- North Austin Med. Ctr.	Revision	12, June 2014	1
		Revision	13, June 2014	- 1
		Revision	18, July 2014	
les Rep:	Diana Barcafar	Revision	25, Aug. 2014	
R/PM:		Revision	27, Aug. 2014	


(Nom.) 120'-6"

	Drawn By:	Production late:
114	RHK	Work Order #TBD
014	RHK	
014	RHK	Approved By:
14	RHK	Approved Date:
014	RHK	
014	RHK	Customer approval is required pri

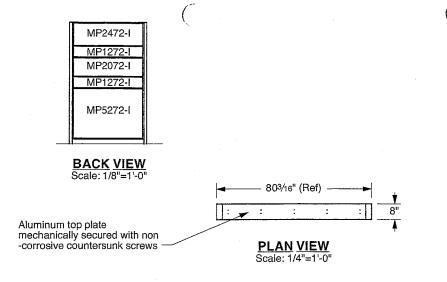

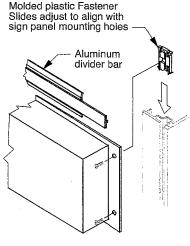

**DETAIL '1': FASTENER SLIDE** Scale: None

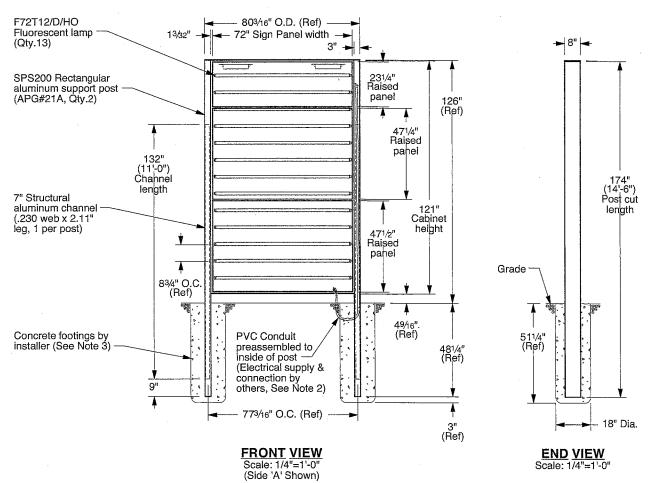

#### NOTES:

1. Refer to presentation drawing and/or work order for colors, graphics specifications and sign panel sizes.

\_V Electrical supply, conduit and associated fittings are by others. Installer to increase footing size as required to route conduit. Electrical connection performed by certified persons.

3. Footings are shown for reference only. Actual design and installation performed by

certified persons based on local codes and geographic practices.

4. Lifting bolts are provided to assist with sign installation. Lifting brackets are accessible by removing post caps. Remove bolts after installation and replace post caps.

Location(s) 24

APPROVAL BY: -REQUIRED DATE: \_



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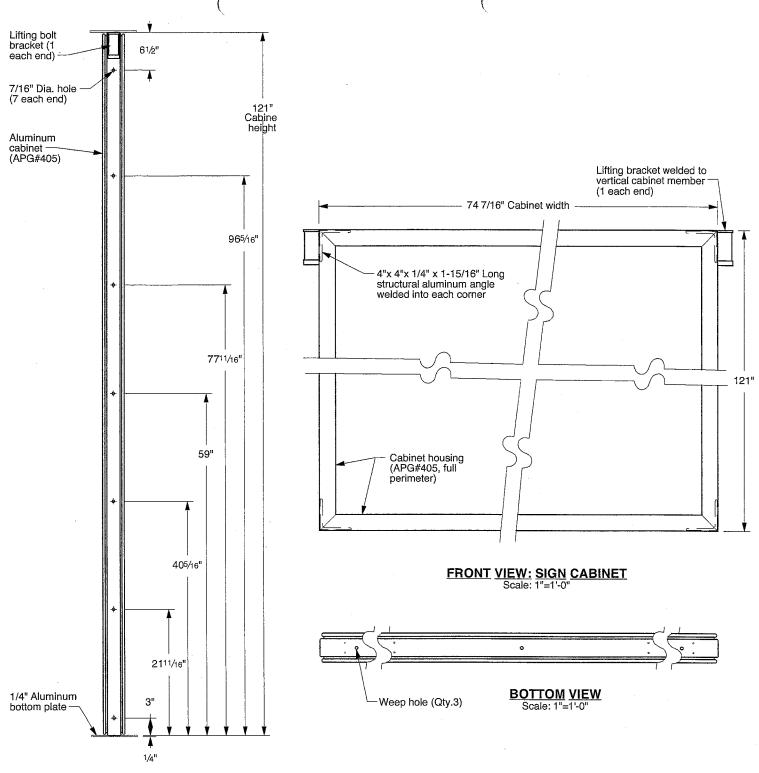
All Design Rights Reserved

Customer: North Austin Medical Center

Project: Exterior Main Entrance Location '24' - Elevation Views Product: 4420 MultiPanel PolySign Double Post Mount, Illuminated

Date: 10/01/14 Drawn: WWD Scale: As Shown Coord.: DTS W.O.#: 437581

Sheet: 24.a



#### **END VIEW: SIGN CABINET**

Scale: 3/4"=1'-0" (Left end shown: Right end typical)

Location(s)		
24		

NOTES:

1. Refer to presentation drawing and/or work order for colors, graphics specifications and sign panel sizes.

APPROVAL BY: \_\_\_\_\_\_\_REQUIRED DATE: \_\_\_\_\_



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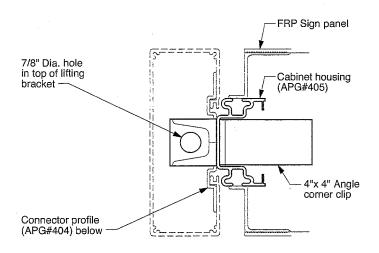
All Design Rights Reserved

Customer: North Austin Medical Center
Project: Exterior Main Entrance
Location '24' - Cabinet Details


Product: 4420 MultiPanel PolySign
Double Post Mount, Illuminated


Date: 10/01/14 Drawn: WWD Scale: As Shown Coord.: DTS W.O.#: 437581

Sheet: 24.b




# SECTION: "24.c1" Scale: 1/4"=1"

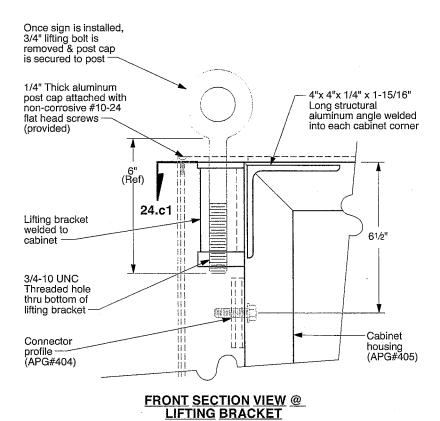


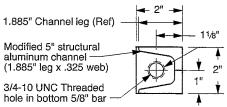

Scale: 1/4"=1"

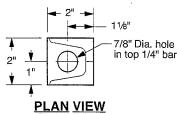

Scale: 1/4"=1

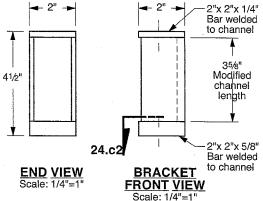

#### NOTES:

1. Lifting bolts are provided to assist with sign installation. Lifting brackets are accessible by removing post caps. In order to maintain structural integrity of the cabinet, use spreader beam and maintain a 90° angle between cabinet and both lifting bolts. Remove bolts after installation and replace post caps.

Scale: 1/4"=1

Location(s) 24

APPROVAL BY: REQUIRED DATE:



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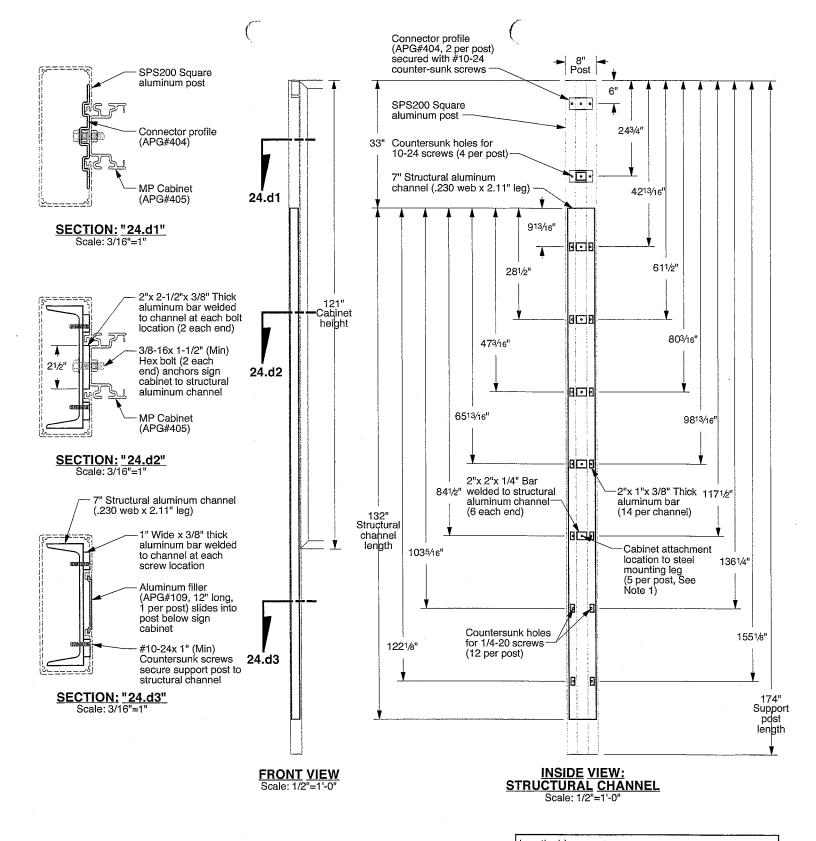
All Design Rights Reserved

Customer: North Austin Medical Center Project: Exterior Main Entrance

Location '24' - Lifting Bracket Details
Product: 4420 MultiPanel PolySign
Double Post Mount, Illuminated

Date: 10/01/14 Drawn: WWD Scale: As Shown Coord.: DTS W.O.#: 437581

Sheet: 24.c



NOTES:

1. Lifting bolts are provided to assist with sign installation. Lifting brackets are accessible by removing post caps. In order to maintain structural integrity of the cabinet, use spreader beam and maintain a 90° angle between cabinet and both lifting bolts. Remove bolts after installation and replace post caps.

Location(s) 24

APPROVAL BY: -REQUIRED DATE: .



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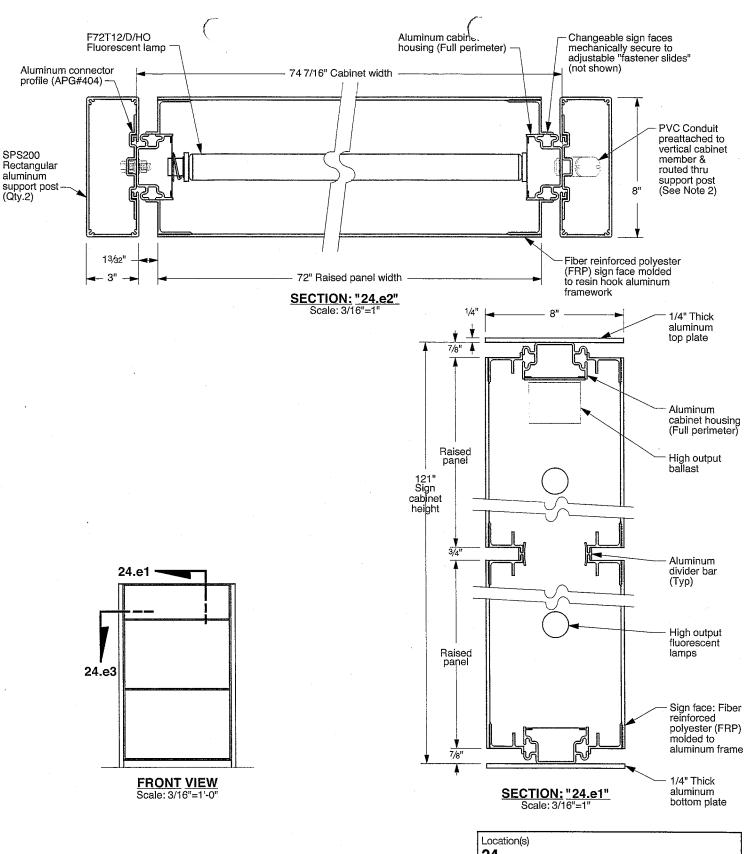
Customer: North Austin Medical Center

Project: Exterior Main Entrance Location '24' - Structural Channel Details

Product: 4420 MultiPanel PolySign Double Post Mount, Illuminated

Date: 10/01/14 Drawn: WWD Scale: As Shown Coord.: DTS W.O.#: 437581

Sheet: 24.d



NOTES:

1. Refer to presentation drawing and/or work order for colors, graphics specifications and sign panel sizes.

V Electrical supply, conduit and associated fittings are by others. Installer to increase footing size as required to route conduit. Electrical connection performed by certified persons.

24

APPROVAL BY: -REQUIRED DATE: -



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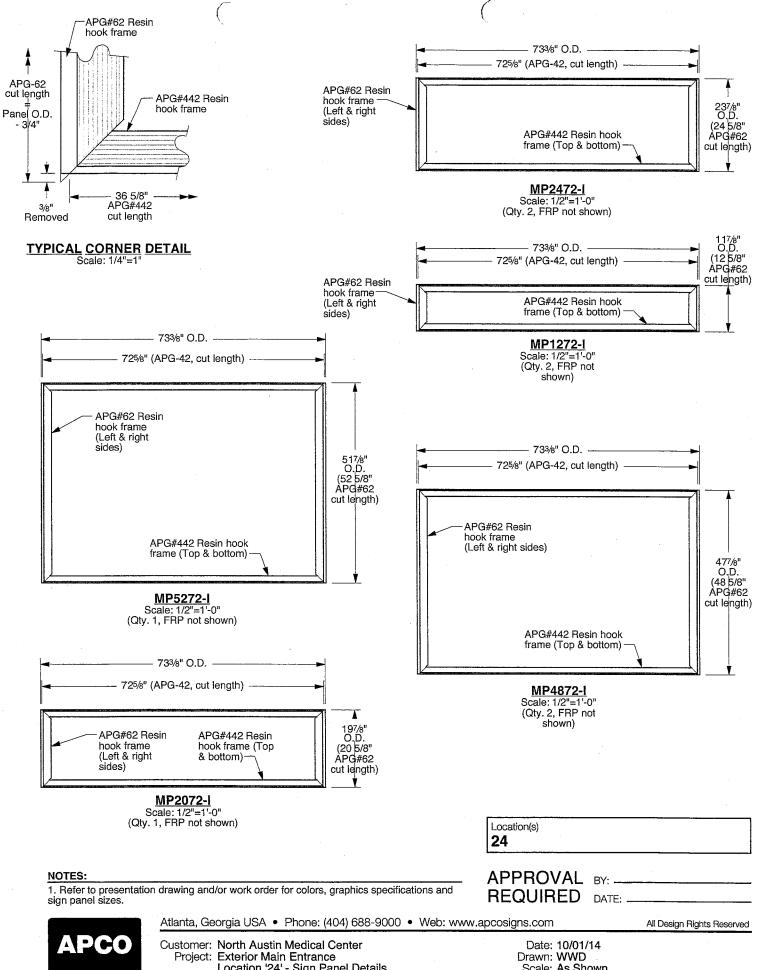
All Design Rights Reserved

Customer: North Austin Medical Center Project: Exterior Main Entrance

Location '24' - Section Views
Product: 4420 MultiPanel PolySign Double Post Mount, Illuminated

Date: 10/01/14 Drawn: WWD Scale: As Shown Coord.: DTS W.O.#: 437581

Sheet: 24.e





apcosigns.com

Location '24' - Sign Panel Details
Product: 4420 MultiPanel PolySign
Double Post Mount, Illuminated

Scale: As Shown Coord.: DTS W.O.#: 437581

Sheet: 24.f

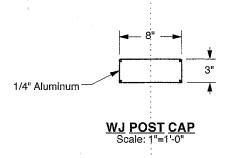

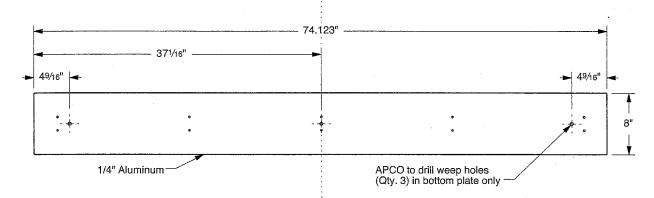

WJ TOP/BOTTOM PLATE
Scale: 1"=1'-0"

Location(s)
24

NOTES

1. Refer to presentation drawing and/or work order for colors, graphics specifications and sign panel sizes.

APPROVAL BY: \_\_\_\_\_\_REQUIRED DATE: \_\_\_\_\_



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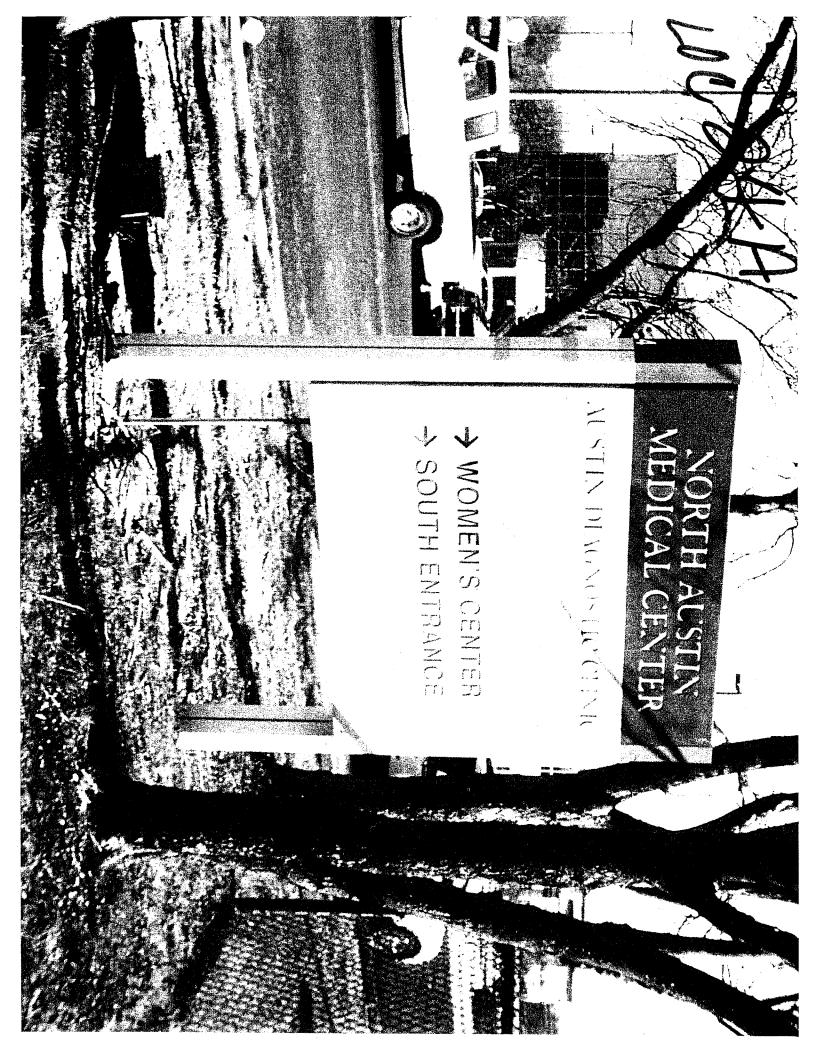
All Design Rights Reserved


Customer: North Austin Medical Center
Project: Exterior Main Entrance
Location '24' - Water-Jet Parts

Product: 4420 MultiPanel PolySign
Double Post Mount, Illuminated

Date: 10/01/14 Drawn: WWD Scale: As Shown Coord.: DTS W.O.#: 437581

Sheet: 24.g



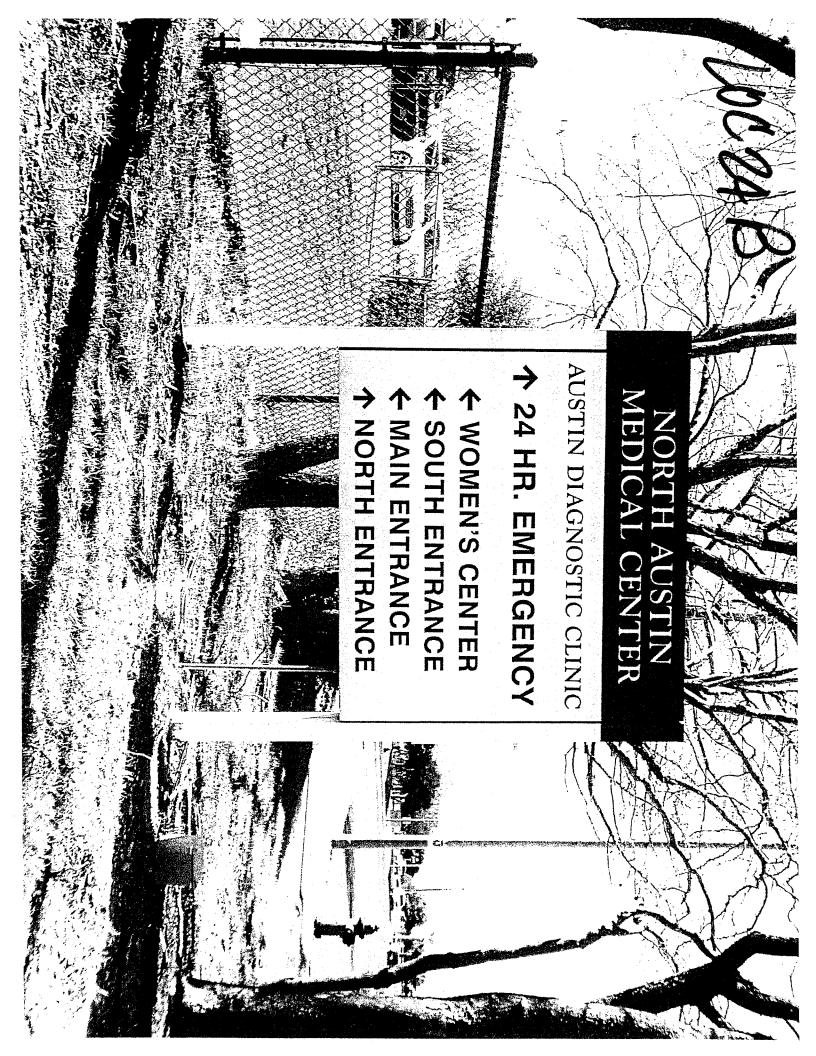



# 26

case#<u>CN0-2015-</u>0002

# CITY OF AUSTIN YOU APPLICATION TO SIGN REVIEW BOARD SIGN VARIANCE

TAX# 02601 3090

WARNING: Filing of this appeal stops all affected construction activity.

(NCADV)

PLEASE: TYPE AND COMPLETE ALL REQUESTED INFORMATION.

STREET ADDRESS: 12221 N Mo-Pac Expressway Austin, TX 78758
LEGAL DESCRIPTION: Subdivision – 36.3670 A
Lot(s) 1 Block B Outlot Centrum Division The Resub of Blk B & E
I/We Michael A. Hunter on behalf of myself/ourselves as authorized agent for
St. David's North Austin Medical Center affirm that on October , 2014, hereby apply for a hearing before
the Sign Review Board for consideration:
ERECT – ATTACH – COMPLETE – REMODEL – MAINTAIN
Erect a new monument directional sign
· · · · · · · · · · · · · · · · · · ·
in azoning district and located within the Scenic Roadway Sign District.

If your variance request is for a reduction in setbacks or height limits, please contact Eben Kellogg with the Electric Utility at (512)322-6050 and send him a scan of your request to <a href="mailto:eben.kellogg@austinenergy.com">eben.kellogg@austinenergy.com</a> before filing your application with this office to discuss your request. The Electric Utility will recommend the board deny your request if it will result in an encroachment into an electric easement or a NESC violation.

NOTE: The Board must determine the existence of, sufficiency of and weight of evidence supporting the findings described below. In order to grant your requeste for a variance, the Board must first make one or more of the findings described under 1, 2, and 3 below; the Board must then make the finding described in item 4 below. If the Board cannot make the required findings, it cannot approve a sign variance.

Therefore, you must complete each of the applicable Findings Statements as part of your application. Failure to do so may result in your application being rejected as incomplete. Please attach any additional support documents.

VARIANCE FINDINGS: I contend that my entitlement to the requested variance is based on the following findings:
1. The variance is necessary because strict enforcement of the Article prohibits any reasonable opportunity to provide adequate signs on the site, considering the unique features of a site such as its dimensions, landscaping, or topography, because: The new proposed sign is of the
same type and design as previously approved signs for this property in Phase 1
approximately 2 years ago.
OR,
2. The granting of this variance will not have a substantially adverse impact upon neighboring properties, because: We are replacing an existing sign of the same nature in the
same location.
OR,
3. The granting of this variance will not substantially conflict with the stated purposes of this sign ordinance, because: The additional size is needed to convey directions to various
medical facilities within the campus
AND,
4. Granting a variance would not provide the applicant with a special privilege not enjoyed by others similarly situated or potentially similarly situated, because: This is an emergency med-
ical facility that needs to be able to convey directional information to those in need of emergency medical care.  APPLICANT CERTIFICATE – I affirm that my statements contained in the complete application are true and correct to the best of my knowledge and belief.
Signed Meihal A Dut. Mail Address 7733 Harwell St
City, State & Zip_Fort Worth, Texas 76108
Printed Michael A Hunter Phone 817-246-4848 Date 10/30/2014
OWNERS CERTIFICATE – I affirm that my statements contained in the complete application are true and correct to the best of my knowledge and belief.
Signed // Wichard / Hunter Mail Address 7733 Harwell St
City, State & Zip_Fort Worth, Texas 76108
Printed Michael A. Hunter Phone 817-246-4848 Date 10/30/2014

4420 PolySign Multi-Panel Series
Double Posts and Pylon
Internally Illuminated Double Sided Graphics \*

Multi-Panel: (Side A & B Logo Panel) MP2472-123.25" x 72") Backgrd, Color: A27 Deep Gr¢Øpaque)

Support Posts:
Part Code: SPS20(3"x 8" Rectangular)
Color: A46 Off White

Illuminated Graphics: Logo: LTBD (St. David s NAMC) Size: 9" Copy: GoudyOldStyle BD BT Size: 6 1/4" & 4 11/16/Small Caps) Color: A01 WhiteTranslucent) Color: A01 Whit@Translucent)

MP1 272-Y11.25" x 72") Multi-Panels: (Side A Message Panels) d. Color: A46 Off Whitapaque)

MP3572-(34.25" x 72") Backgrd. Color: A46 Off Wh(Gpaque) MP2072-{18.25" x 72") Backgrd. Color: A46 Off Wh\@paque)

Backgrd. Color: A46 Off Whitepaque) MP3572-(34.25" x 72")

CHILDREN'S

EMERGENCY

EMERGENCY

Color: DayLit@Translucent)
Color: A69 American R@Translucent)

Multi-Panels: (Side B Message Panels)
MP5172/56.25" x 72") (Blank) (Aty. 2)
Backgrd. Color: A46 Off Wh'(Bpaque)

North & West

Entrances

34-1/4"

go fils available for Production Use.

Illuminated Graphics: Arrow: A120 Copy: GoudyOldStyle BD BT Copy: Comic Sans Bold Size: 5" Color: DayLitéTranslucent)
Color: A69 American Rétranslucent)

S†David's PLAN VIEW NORTH AUSTIN MEDICAL CENTER 80-3/16" 72" 17-1/4"

Women's Center 34.1/4" 19-1/4" 11-1/4" 5

East & South

Entrances

Colors depicted are a general representation of the color specified. If color selection is critical, please request sample for approval.

(Blank Except Header) SIDE B



All Design Rights Reserve

18"

Sign Type B - Location 26

SIDE A

3,000 PSI Concrete

uarters	
Ε	
-2227	
Fax: 404.577.3847	
niano com	

Project Role	erence:
Project:	Children's EMERGENCY - North Austin Med. Ctr.

Original
Addition
Rev. 1
Revision

D

В Location 26 4420 PolySign Series

1/2" = 1 -0"

apcosigns.com


Sales Rep:


Diana Barcafar CSR/PM:


RHK


Customer approval is required prior to product

n.Scale:

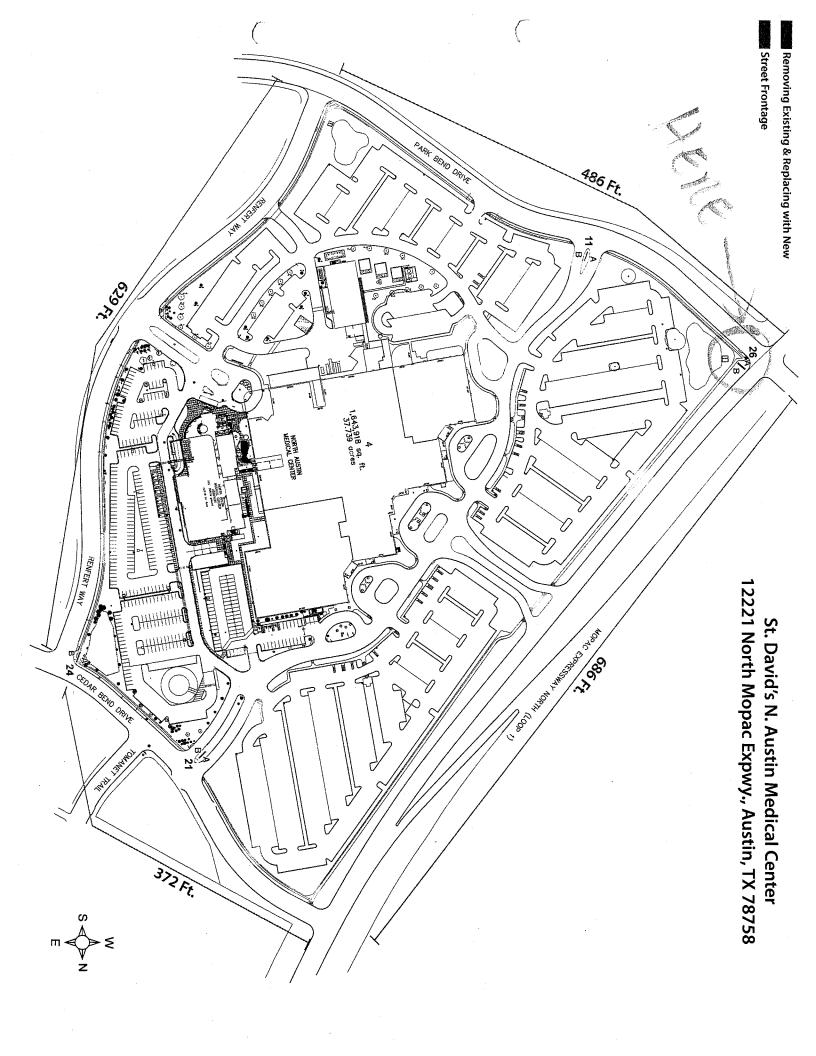


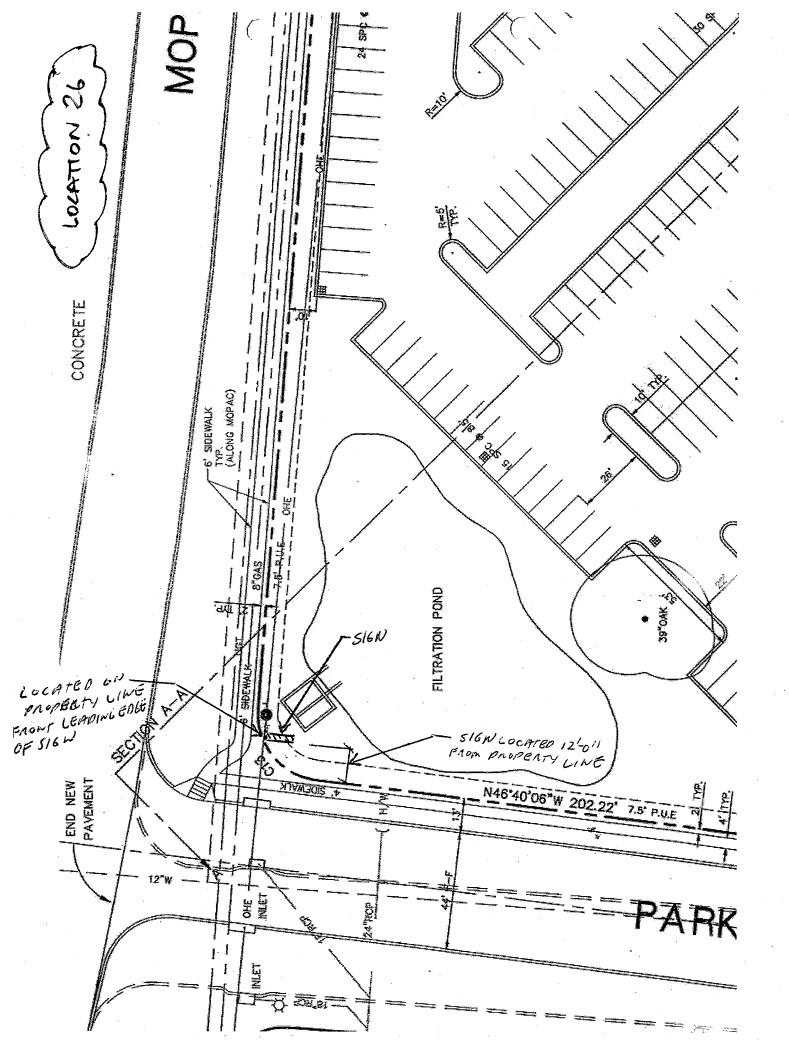


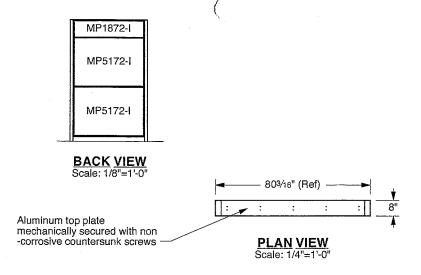

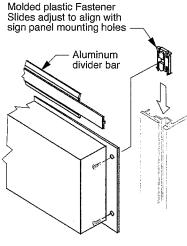

**DETAIL '1': FASTENER SLIDE** Scale: None

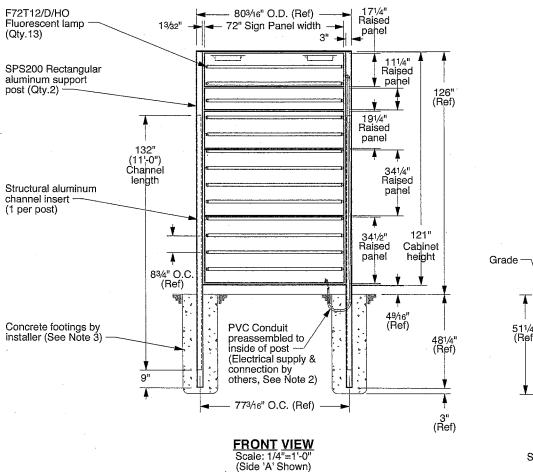

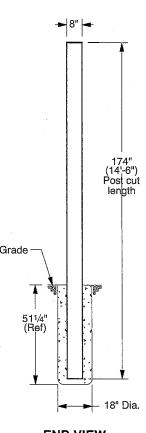

**END VIEW** Scale: 1/4"=1'-0'

#### NOTES:

1. Refer to presentation drawing and/or work order for colors, graphics specifications and sign panel sizes.

V Electrical supply, conduit and associated fittings are by others. Installer to increase footing size as required to route conduit. Electrical connection performed by certified persons.

3. Footings are shown for reference only. Actual design and installation performed by

certified persons based on local codes and geographic practices.

4. Lifting bolts are provided to assist with sign installation. Lifting brackets are accessible by removing post caps. Remove bolts after installation and replace post caps.

Location(s)	 
26	
<u> </u>	 

	BY:
REQUIRED	DATE:



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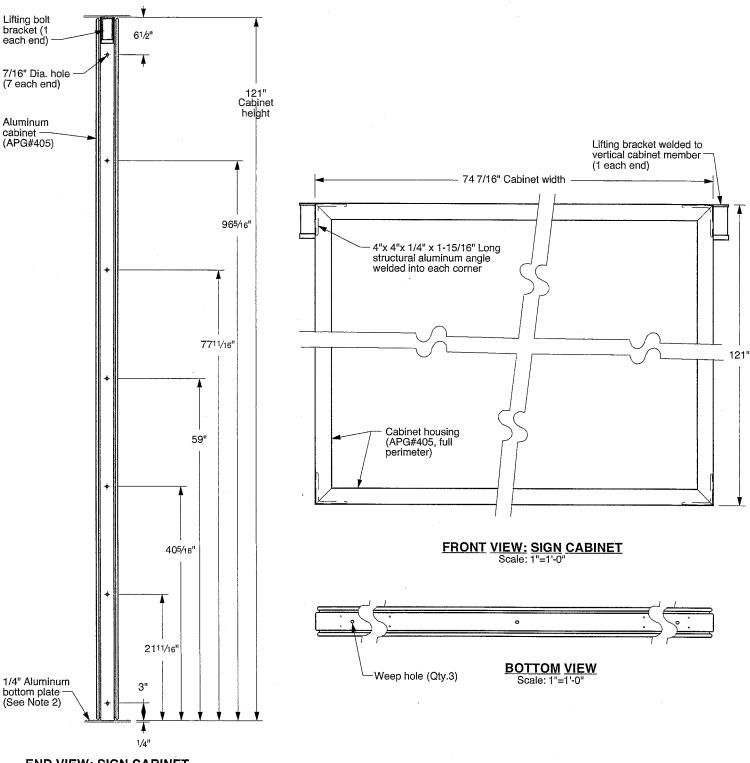
All Design Rights Reserved

Customer: North Austin Medical Center Project: Exterior Main Entrance

Location '26' - Elevation Views Product: 4420 MultiPanel PolySign Double Post Mount, Illuminated

Date: 10/01/14 Drawn: WWD Scale: As Shown Coord.: DTS W.O.#: 437581

Sheet: 26.a



END VIEW: SIGN CABINET
Scale: 3/4"=1'-0"

(Left end shown: Right end typical)

11 42 4-3	
Location(s)	
26	
120	

NOTES:

1. Refer to presentation drawing and/or work order for colors, graphics specifications and sign panel sizes.

APPROVAL BY: \_\_\_\_\_\_REQUIRED DATE: \_\_\_\_\_



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Customer: North Austin Medical Center Project: Exterior Main Entrance


Location '26' - Cabinet Details

Product: 4420 MultiPanel PolySign


Double Post Mount, Illuminated


Date: 10/01/14 Drawn: WWD Scale: As Shown Coord.: DTS W.O.#: 437581

Sheet: 26.b

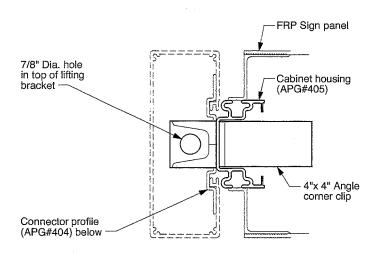


## Scale: 1/4"=1"

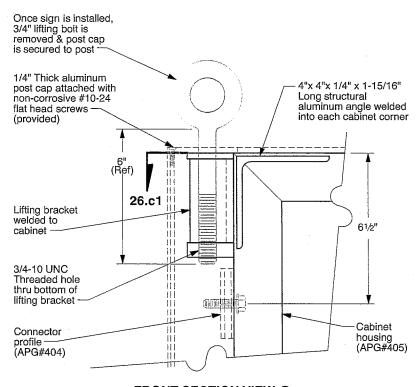


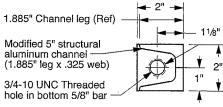

**SECTION: "26.c2"** Scale: 1/4"=1

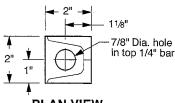

PLAN VIEW Scale: 1/4"=1"

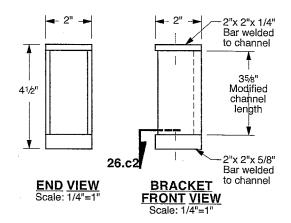

#### FRONT SECTION VIEW @ **LIFTING BRACKET**

NOTES:

1. Lifting bolts are provided to assist with sign installation. Lifting brackets are accessible by removing post caps. In order to maintain structural integrity of the cabinet, use spreader beam and maintain a 90° angle between cabinet and both lifting bolts. Remove bolts after installation and replace post caps.

Location(s) 26

APPROVAL BY: -REQUIRED DATE: -

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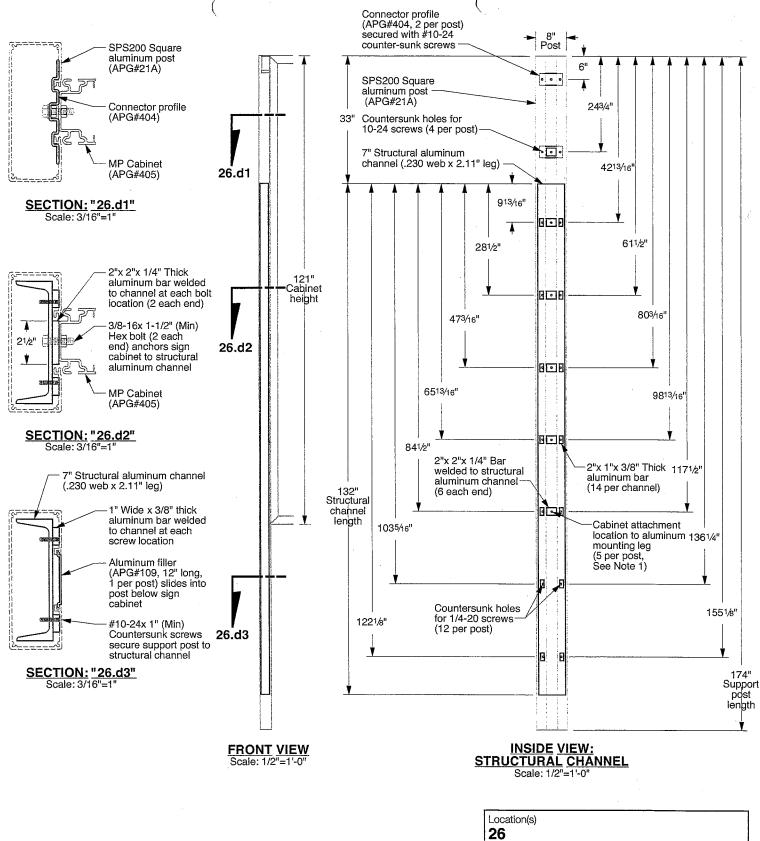
Customer: North Austin Medical Center Project: Exterior Main Entrance

Location '26' - Lifting Bracket Details
Product: 4420 MultiPanel PolySign
Double Post Mount, Illuminated

Date: 10/01/14 Drawn: WWD Scale: As Shown Coord.: DTS W.O.#: 437581.

Sheet: 26.c

apcosigns.com



NOTES:

1. Lifting bolts are provided to assist with sign installation. Lifting brackets are accessible by removing post caps. In order to maintain structural integrity of the cabinet, use spreader beam and maintain a 90° angle between cabinet and both lifting bolts. Remove bolts after installation and replace post caps.

APPROVAL BY: -REQUIRED DATE: \_



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Customer: North Austin Medical Center


Project: Exterior Main Entrance

Location '26' - Structural Channel Details

Product: 4420 MultiPanel PolySign

Double Post Mount, Illuminated

Date: 10/01/14 Drawn: WWD Scale: As Shown Coord.: DTS W.O.#: 437581

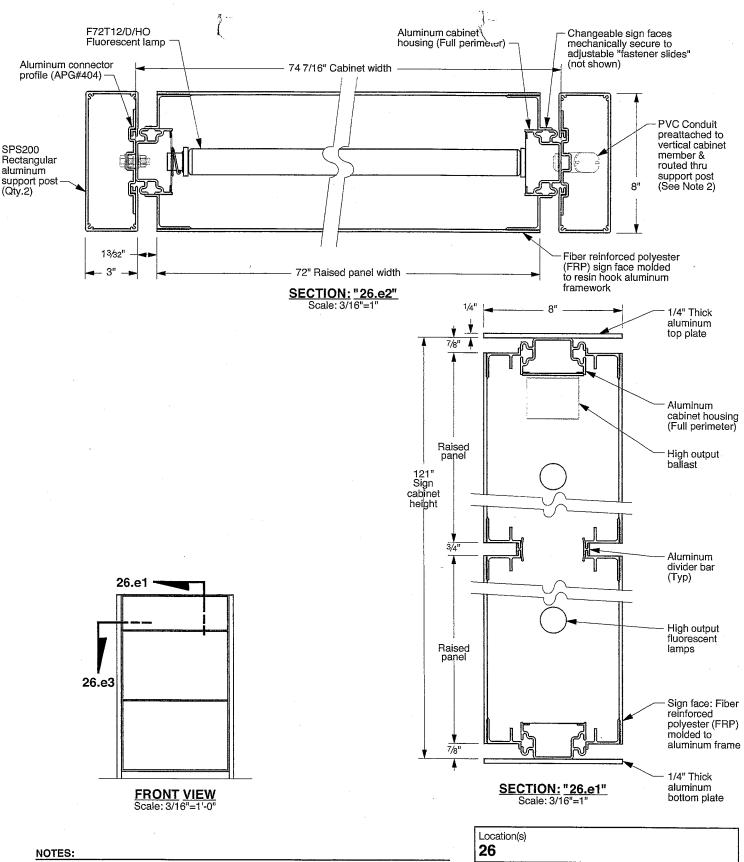

1. Refer to presentation drawing and/or work order for colors, graphics specifications and sign panel sizes.

2. V Electrical supply, conduit and associated fittings are by others. Installer to increase footing size as required to route conduit. Electrical connection performed by certified persons.

APPROVAL BY: . REQUIRED DATE: -



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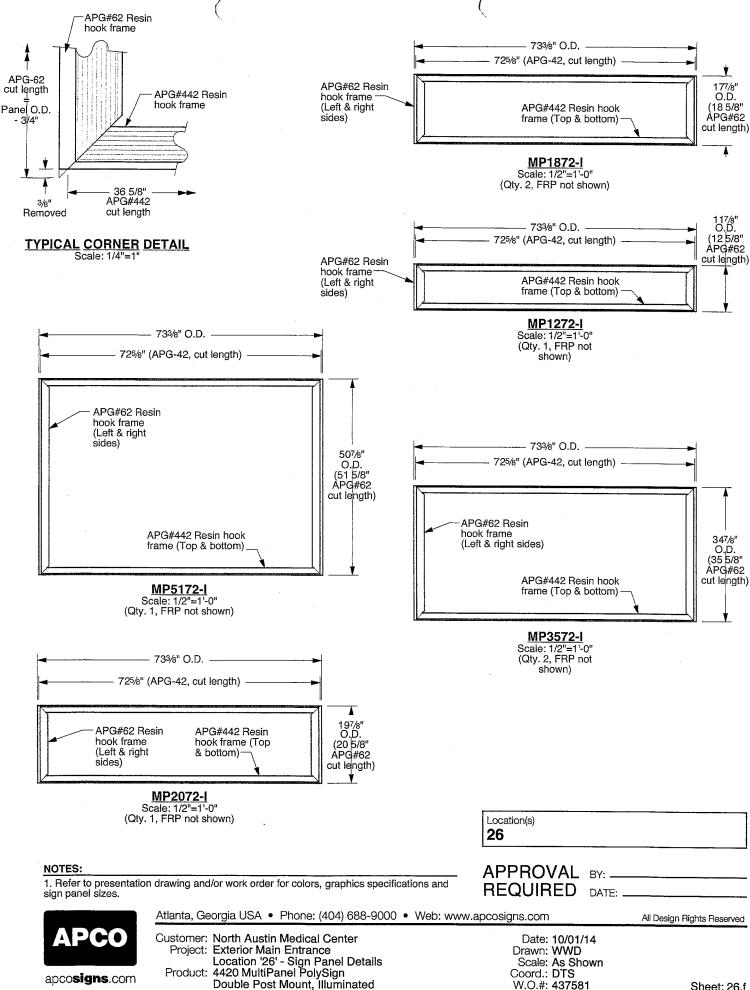
Customer: North Austin Medical Center Project: Exterior Main Entrance

Location '26' - Section Views Product: 4420 MultiPanel PolySign Double Post Mount, Illuminated

Date: 10/01/14 Drawn: WWD Scale: As Shown Coord.: DTS W.O.#: 437581


apcosigns.com

Sheet: 26.e




W.O.#: 437581

Sheet: 26.f

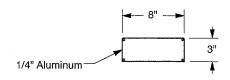

#### WJ POST CAP Scale: 1"=1'-0"

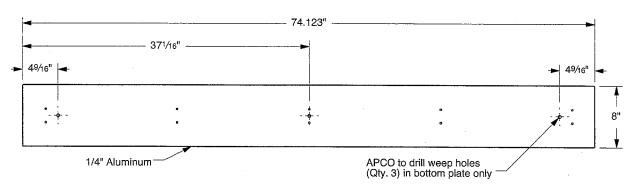

### WJ TOP/BOTTOM PLATE Scale: 1"=1'-0"

	Location(s) 26
NOTES:	APPROVAL BY:REQUIRED DATE:



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Customer: North Austin Medical Center
Project: Exterior Main Entrance
Location '26' - Water-Jet Parts
Product: 4420 MultiPanel PolySign
Double Post Mount, Illuminated

Date: 10/01/14 Drawn: WWD Scale: As Shown Coord.: DTS W.O.#: 437581

Sheet: 26.g



